

Residential New Construction

4 BEDROOM - 3 BATHROOM - 1 POWDER ROOM - 2 CAR GARAGE

AD DESIGNS LLC (248) 747-0554 info@admoderndesigns.com

	REVISION	ONS

RESIDENCE AT **S. Gord**1666 S Gord
Atlanta, GA SINGLE

OWNER:

Name: Trent White Company: Triton Holdings Contact: twhite@triton.holdings



Release For Construction

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A-100

Scale

General Notes

- 1. GENERAL NOTES APPLY TO ALL DRAWINGS
- 2. DO NOT SCALE DRAWINGS. ANY DIMENSIONAL INFORMATION REQUIRED WHICH IS NOT INDICATED ON DRAWING DIMENSION STRINGS SHALL BE OBTAINED FROM THE ARCHITECT
- 3. DIMENSIONS SHOWN ARE FINISH SURFACE OF EXISTING CONSTRUCTION, UNLESS NOTED OTHERWISE.
- 4. CONTRACTOR SHALL VERIFY ALL EXISTING DIMENSIONS AND CONDITIONS (I.E. EXISTING MATERIALS, FRAMING MEMBER SIZES AND LOCATIONS, METHODS OF CONSTRUCTION). IF DISCREPANCIES ARE FOUND, NOTIFY ARCHITECT BEFORE PROCEEDING WITH WORK.
- 5. CONTRACTOR SHALL PAY ALL PERMIT FEES.
- 6. CONTRACTOR SHALL MAINTAIN THE IMMEDIATE CONSTRUCTION SITE IN A SECURE, CLEAN AND SAFE MANNER
- 7. PROTECTION: CONTRACTORS SHALL BE SOLELY RESPONSIBLE FOR TAKING ALL STEPS NECESSARY TO PROTECT THE PUBLIC FROM INJURY AND ADJACENT PROPERTY DAMAGES DURING CONSTRUCTION AS REQUIRED BY LOCAL CODES.
- 8. REPAIR ALL EXISTING CONSTRUCTION AFFECTED BY NEW WORK TO ITS ORIGINAL CONDITION

Code Summary

International Building Code,

2018 Edition, with Georgia Amendments (2020) - (Effective January 1, 2020)

International Residential Code,

2018 Edition, with Georgia Amendments (2020) - (Effective January 1, 2020)

International Fire Code,

2018 Edition, with Georgia Amendments (2020) - (Effective January 1, 2020)

International Plumbing Code,

2018 Edition, with Georgia Amendments (2020) - (Effective January 1, 2020)

International Mechanical Code,

2018 Edition, with Georgia Amendments (2020) - (Effective January 1, 2020)

International Fuel Gas Code,

2018 Edition, with Georgia Amendments (2020) - (Effective January 1, 2020)

National Electrical Code,

2020 Edition, with no Georgia Amendments (Effective February 1, 2021).

International Energy Conservation Code, 2015 Edition, with Georgia Supplements and Amendments (2020) - (Effective January 1, 2020)

International Swimming Pool and Spa Code,

2018 Edition, with Georgia Amendments (2020) - (Effective January 1, 2020)

Life Safety Code 2018 Edition with State Amendments (2020) - (Effective January 1, 2020)

Building Square Footage

1st Floor: 1818.54 sqft 2nd Floor: 1486.88 sqft Garage: 479 sqft

Total: 3784.42

<u>Heated Area</u>	<u>Unheated Area</u>
1st Floor: 1818.54 sqft	2 Car Garage : 479 sq

Total: 3305.42 sqft

2nd Floor: 1486.88 sqft

Total: 479 sqft

Sheet Number	Sheet Name
A-100	Cover Sheet
A-101	General Note
A-102	Proposed 1st Floor Plan
A-103	Proposed 2nd Floor Plan
A-104	Proposed Elevation
A-105	Proposed Elevation
A-106	Schedules
E1	Electrical Plan
S1	Details
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S100	Foundation Plan
S101	1st Floor Framing Plan
S102	2nd Floor Framing Plan
S-103	Roof Plan

Scope of Work

Single Family New Construction Home New Driveway New Wood Framed Structure

GENERAL NOTES AND SPECIFICATIONS

THE GENERAL CONTRACTOR SHALL FULLY COMPLY WITH THE 2015 IBC AND ALL ADDITIONAL STATE AND LOCAL CODE REQUIREMENTS.

2015 IEC AND 2015 IMC SHALL BE USED.

THE CONTRACTOR SHALL ASSUME FULL RESPONSIBILITY FOR ANY WORK KNOWINGLY PERFORMED CONTRARY TO SUCH LAWS, ORDINANCES, OR REGULATIONS. THE CONTRACTOR SHALL ALSO PERFORM COORDINATION WITH ALL UTILITIES AND

STATE SERVICE AUTHORITIES.

WRITTEN DIMENSIONS ON THESE DRAWINGS SHALL HAVE PRECEDENCE OVER SCALED DIMENSIONS. THE GENERAL

CONTRACTOR SHALL VERIFY AND IS RESPONSIBLE FOR ALL DIMENSIONS (INCLUDING ROUGH OPENINGS) AND CONDITIONS ON THE JOB AND MUST NOTIFY DESIGNER OF ANY VARIATIONS FROM THESE DRAWINGS.

THIS DESIGNER SHALL NOT BE RESPONSIBLE FOR CONSTRUCTION MEANS AND METHODS, ACTS OR OMISSIONS OF THE CONTRACTOR OR SUBCONTRACTOR, OR FAILURE OF ANY OF THEM TO CARRY OUT WORK IN ACCORDANCE WITH THE CONSTRUCTION DOCUMENTS. AND DEFECT DISCOVERED IN THE CONSTRUCTION DOCUMENTS SHALL BE BROUGHT TO THE ATTENTION OF DESIGNER/OWNER BY WRITTEN NOTICE BEFORE PROCEEDING WITH WORK.

DESIGN CRITERIA: 2015 IRC AND IBC ROOF: 30 PSF SNOW LOAD *8 PSF TOP CHORD DEAD LOAD. *7 PSF BOTTOM CHORD DEAD LOAD. *5 PSF NET WIND UPLIFT. FLOOR: 40 PSF LL *10 PSF TOP CHORD DL *5 PSF BOTTOM CHORD DL SOIL: *2,000 PSF ALLOWABLE (ASSUMED) TO BE AT TIME OF EXCAVATION FROST DEPTH: *30" SEISMIC ZONE: B, (ASSUMED) WIND: 115 MPH (115 MPH 3 SÉC GUST), EXPOSURE C. (ASSUMED) THIS STRUCTURE SHALL BE ADEQUATELY BRACED FOR WIND LOADS UNTIL THE ROOF, FLOOR AND WALLS HAVE BEEN PERMANENTLY FRAMED TOGETHER AND SHEATHED. INSTALL POLYISOCYANURATE FOAM TYPE INSULATION AT FLOOR AND PLATE LINES, OPENINGS IN PLATES, CORNER STUD CAVITIES AND AROUND DOOR AND WINDOW ROUGH OPENING CAVITIES. INSTALL WATERPROOF GYPSUM BOARD AT ALL WATER SPLASH AREAS TO MINIMUM 70" ABOVE SHOWER DRAINS. INSULATE WASTE LINES FOR SOUND CONTROL EXHAUST ALL VENTS AND FANS DIRECTLY TO OUTSIDE VIA METAL DUCTS, PROVIDE 90 CFM (MIN) FANS TO PROVIDE 5 AIR CHANGES PER HOUR IN BATHS CONTAINING TUB AND / OR SHOWER AND IN LAUNDRY ROOMS.

PROVIDE SOLID BLOCKING UNDER ALL BEARING WALLS PERPENDICULAR TO JOISTS AND OTHER

NAILING NOTES: (PER IRC TABLE R602.3(1))

I.C. LABEL.

ALL RECESSED LIGHTS IN INSULATED CEILINGS TO HAVE THE

BEARING POINTS NOT OTHERWISE PROVIDED WITH SUPPORT.

JOIST TO SILL OR GIRDER TOE NAIL (3)-8d BRIDGING TO JOIST TOE NAIL EA. END (2)-8d SOLE PLATE TO JOIST OR BLK'G FACE NAIL 16d @ 16"OC STUD TO SOLE PLATE TOE NAIL (4)-8d, END NAIL (2) 16d TOP PLATE TO STUD END NAIL (2)-16d DOUBLE STUDS FACE NAIL 16d @ 24" OC DOUBLE TOP PLATES FACE NAIL 16d @ 16" OC CONTINUOUS HEADER, TWO PIECES 16d @ 16" OC ALONG EA. EDGE **BUILT-UP HEADER, TWO PIECES** W/ 1/2" SPACER 16d @ 16" OC ALONG EA. EDGE TOP PLATES, LAPS AND INTERSECTIONS FACE NAIL (2)-16d CEILING JOISTS TO PLATE TOE NAIL (3)-8d CONTINUOUS HEADER TO STUD TOE NAIL (4)-8d CEILING JOISTS, LAPS OVER PARTITIONS FACE NAIL (3)-10d CEILING JOISTS TO PARALLEL RAFTERS FACE NAIL (3)-10d RAFTER TO PLATE TOE NAIL (2)-16d 1" BRACE TO EACH STUD AND PLATE FACE NAIL (2)-8d BUILT-UP CORNER STUDS 10d @ 24" OC 2" PLANKS (2)-16d @ EA.BRG. 1/2" PLYWOOD ROOF AND WALL EDGES 8d @ 6" OC SHEATHING INTERMEDIATE 8d @ 12" OC 3/4" PLYWOOD SUBFLOOR EDGES 8d @ 6" OC INTERMEDIATE 8d @ 12" OC 2x MULTIPLE JOISTS - STAGGER @ 15" OC W/(2) @ EA. END OR SPLICE (3) OR FEWER 16d NAILS (4) OR MORE 1/2" DIA M.B. W/ STANDARDNUT AND WASHERS.

GRADING NOTES:

- 1. CONTRACTOR TO VERIFY LOCATION OF ALL EXISTING UTILITIES.
- 2. PROVIDE POSITIVE DRAINAGE AWAY FROM BUILDING.
- 3. FINAL GRADE TO CONVEY SURFACE DRAINAGE TOWARD ROCK CHANNELS AND DISPERSION TRENCHES.

5. PLACE FILL SLOPES WITH A GRADIENT STEEPER THAT 3:1 IN LIFTS NOT

- 4. AREAS TO BE FILLED SHALL BE CLEARED, GRUBBED TO REMOVE TREES, VEGETATION,
- ROOTS AND OTHER OBJECTIONABLE MATERIAL AND STRIPPED OF TOPSOIL

RAILING NOTES:

STAIRWAYS SHALL HAVE A MIN. WIDTH OF 34". HAND RAILS MAY ENCROACH A MAX. OF 3 1/2" INTO THE REQUIRED WIDTH.

TREADS SHALL HAVE A MIN. WIDTH OF 9". STAIR TREADS MUST BE UNIFORM AND CAN NOT VARY FROM THE LARGEST TO THE SMALLEST BY MORE THAN 3/8".

STAIRWAYS SHALL HAVE MIN. 6'-8" OF HEADROOM AT THE NOSE OF THE STAIR.

ENCLOSED USABLE SPACE UNDER INTERIOR STAIRS SHALL BE PROTECTED ON THE ENCLOSED FACE WITH 5/8" TYPE "X" GYPSUM WALL BOARD.

STAIRWAYS SHALL HAVE AT LEAST ONE HANDRAIL LOCATED 34" TO 38" ABOVE THE NOSING OF TREADS AND LANDINGS. THE HAND GRIP PORTION OF HANDRAILS SHALL NOT BE LESS THAN 1-1/2" OR GREATER THAN 2" IN CROSS-SECTIONAL DIMENSION.

HANDRAILS SHALL BE CONTINUOUS THE FULL LENGTH OF THE STAIRS. THE ENDS OF HANDRAILS SHALL RETURN TO WALL OR TERMINATE INTO A NEWEL POST OR SAFETY TERMINAL

STAIRWAYS HAVING LESS THAN 2 RISERS DO NOT REQUIRE A HAND RAIL. 34" MIN. HEIGHT GUARDRAILS SHALL BE PROVIDED FOR AT PORCHES. DECKS. BALCONIES. STAIRWAYS

AND LANDINGS WHERE THE ADJACENT SURFACE IS GREATER THAN 24" BELOW. RAILING AND GUARDRAIL BALUSTER SPACING SHALL BE NO GREATER THAN 4".

THE TRIANGULAR OPENINGS FORMED BY THE RISER, TREAD, AND BOTTOM OF GUARDRAIL SHALL NOT ALLOW A 6" DIAMETER SPHERE TO PASS THROUGH.

EXTERIOR SPIRAL STAIRS TO BE FABRICATED AND INSTALLED PER THE MFG. INSTRUCTIONS.

VENTILATION NOTES:

ALL COMBUSTION APPLIANCES WILL BE VENTED DIRECTLY TO THE EXTERIOR. FURNACE FIREBOX AND TANKLESS WATER HEATER SHALL HAVE OUTSIDE COMBUSTION AIR SUPPLY PURSUANT TO REGIONAL AND LOCAL CODES. ATTIC SHALL HAVE VENTILATION EQUAL TO 1 SQ. FOOT PER 150 SQ. FEET OF ATTIC SPACE. VENTILATION SHALL BE PROTECTED FROM SNOW AND RAIN AND SHALL BE COVERED WITH GALVANIZED WIRE SCREEN. OPENINGS SHALL BE LOCATED TO PROVIDE CROSS VENTILATION. EXHAUST ALL VENTS AND FANS DIRECTLY TO OUTSIDE VIA METAL DUCTS, PROVIDE

90 CFM (MIN) FANS TO PROVIDE 5 AIR CHANGES PER HOUR IN BATHS CONTAINING TUB AND / OR SHOWER AND IN LAUNDRY ROOMS.

GARAGES SHALL BE VENTED WITH 60 SQUARE INCHES LOCATED 6" ABOVE THE FLOOR SURFACE.

UNDER FLOOR SPACES SHALL HAVE VENTILATION EQUAL TO ONE SQ. FOOT PER 150 SQ. FEET OF FLOOR SPACE. VENTS SHALL BE CAST INTO THE CONCRETE STEM WALLS AND COVERED WITH GALVANIZED WIRE SCREEN. VENTS SHALL BE LOCATED TO PROVIDE CROSS VENTILATION.



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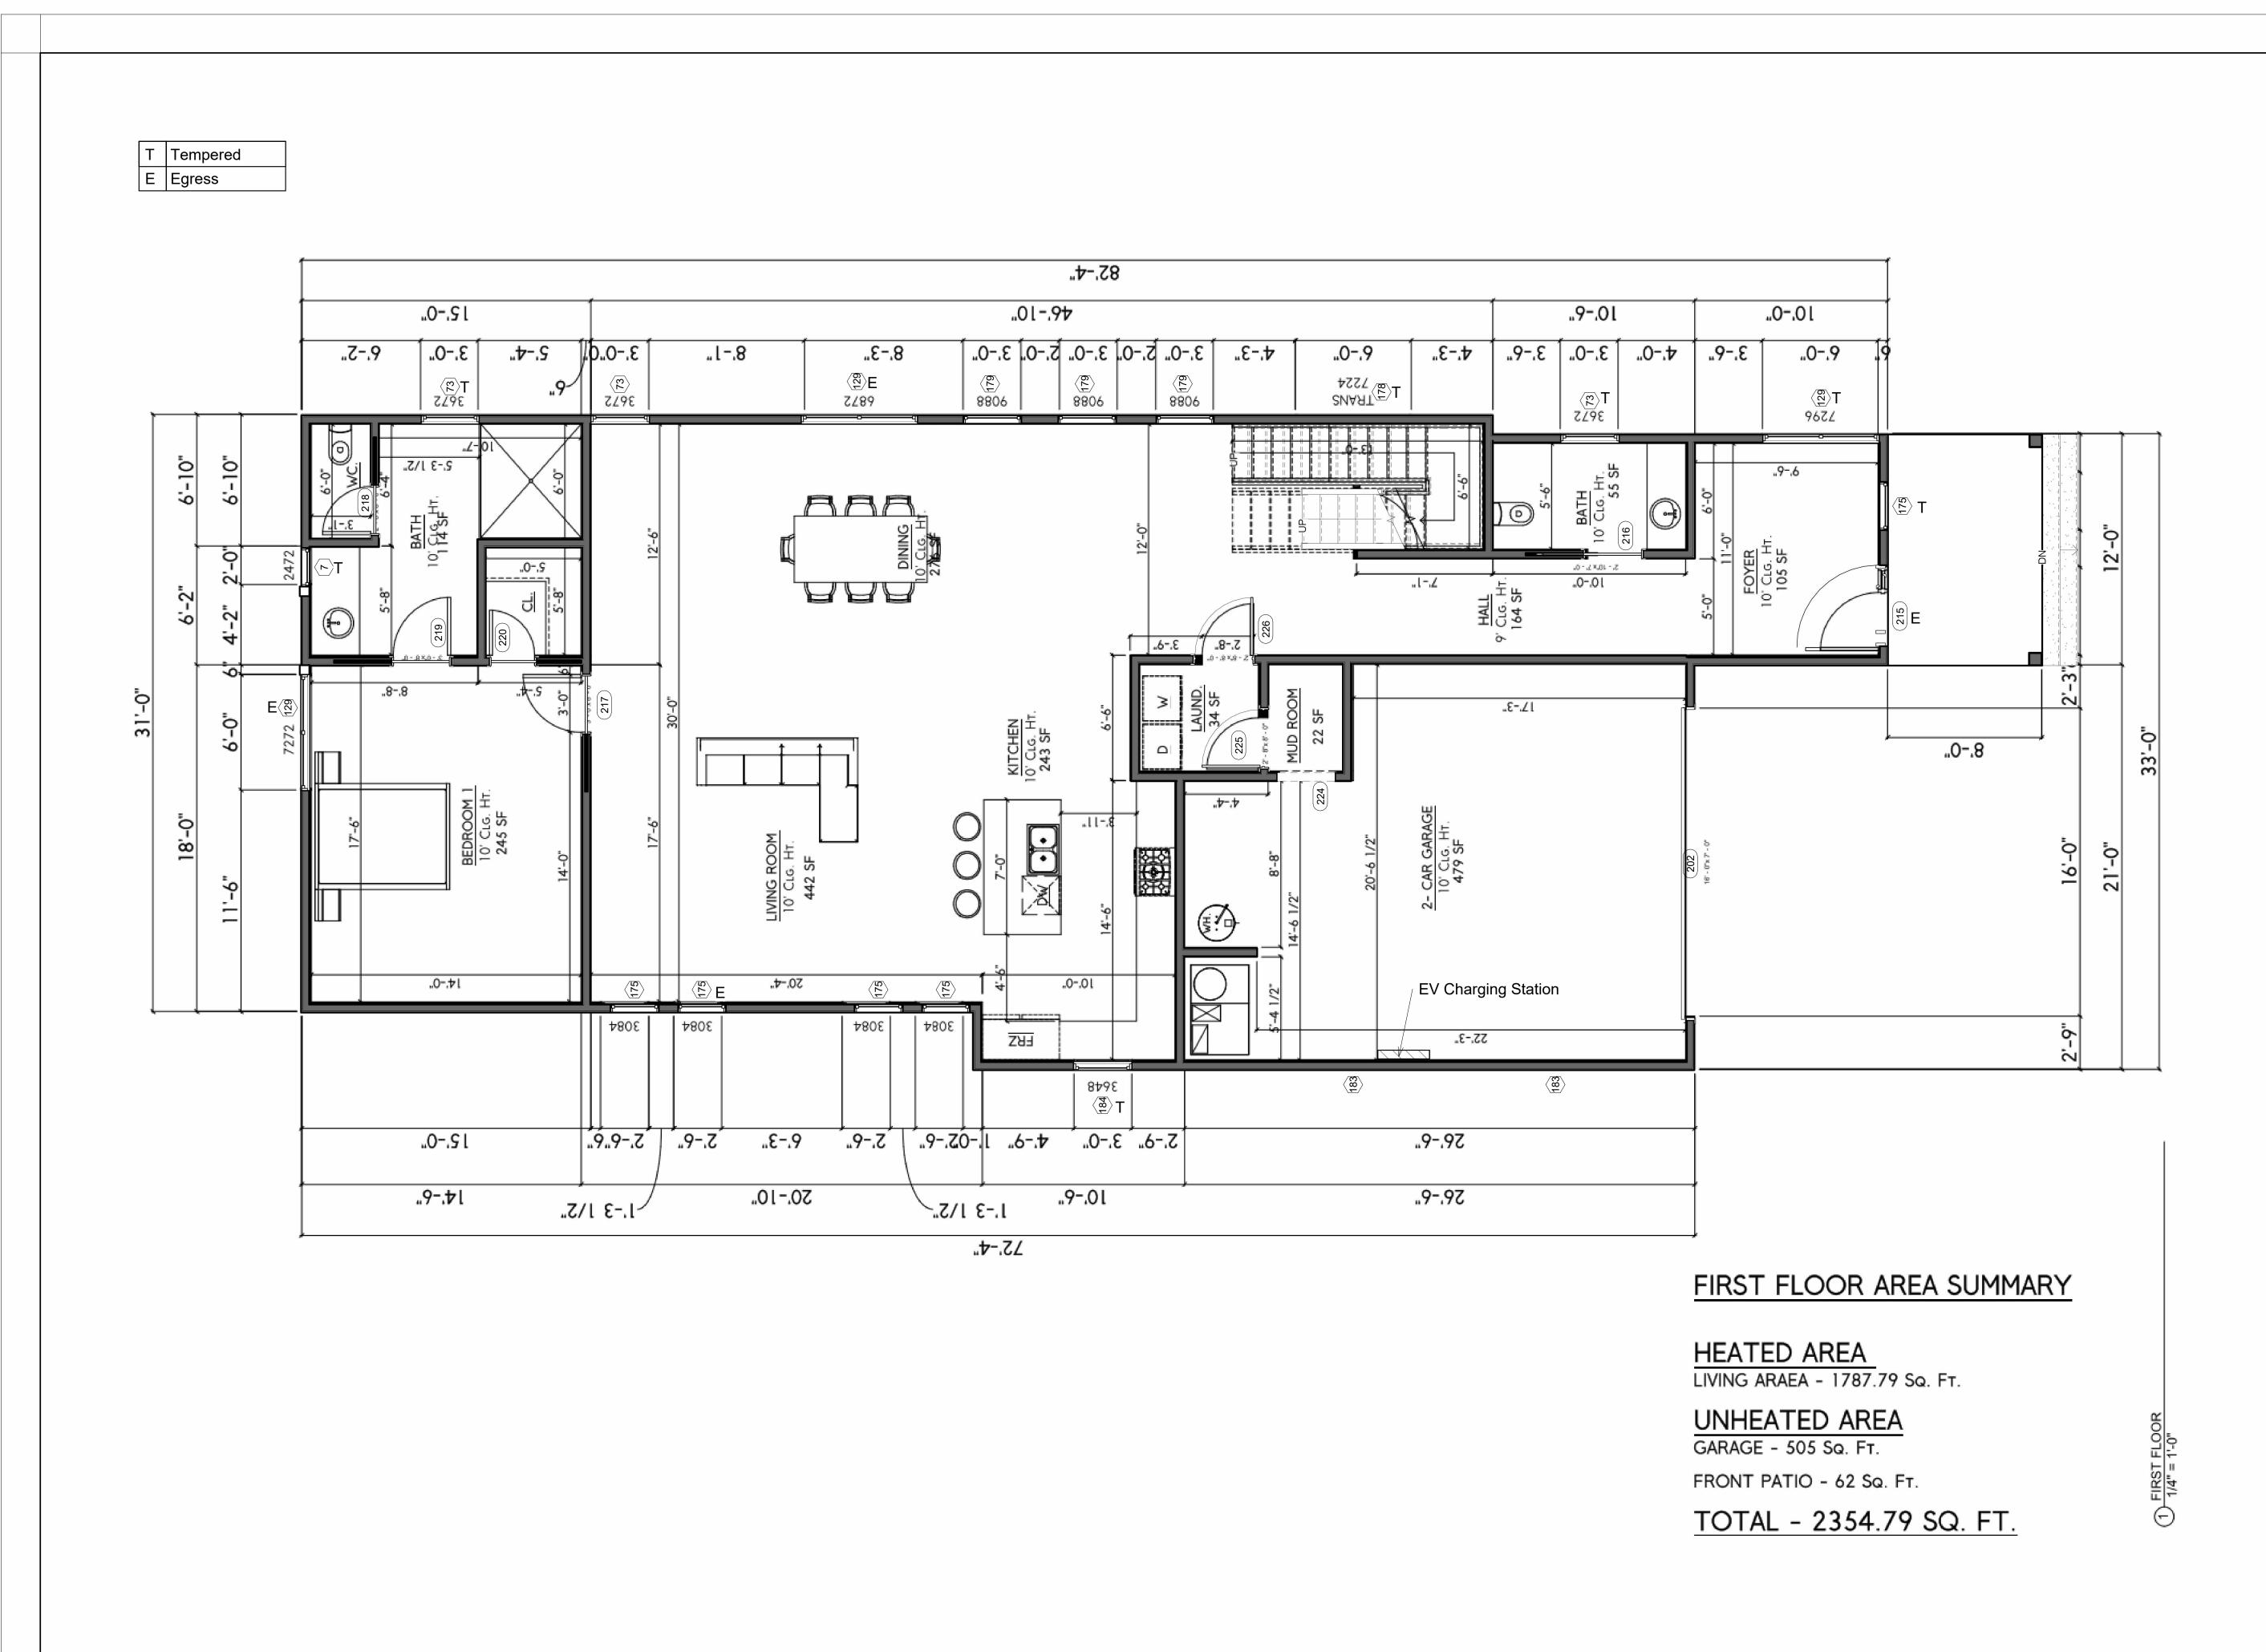
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General Note

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Proposed 1st Floor Plan


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1/4" = 1'-0"

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OWNER:

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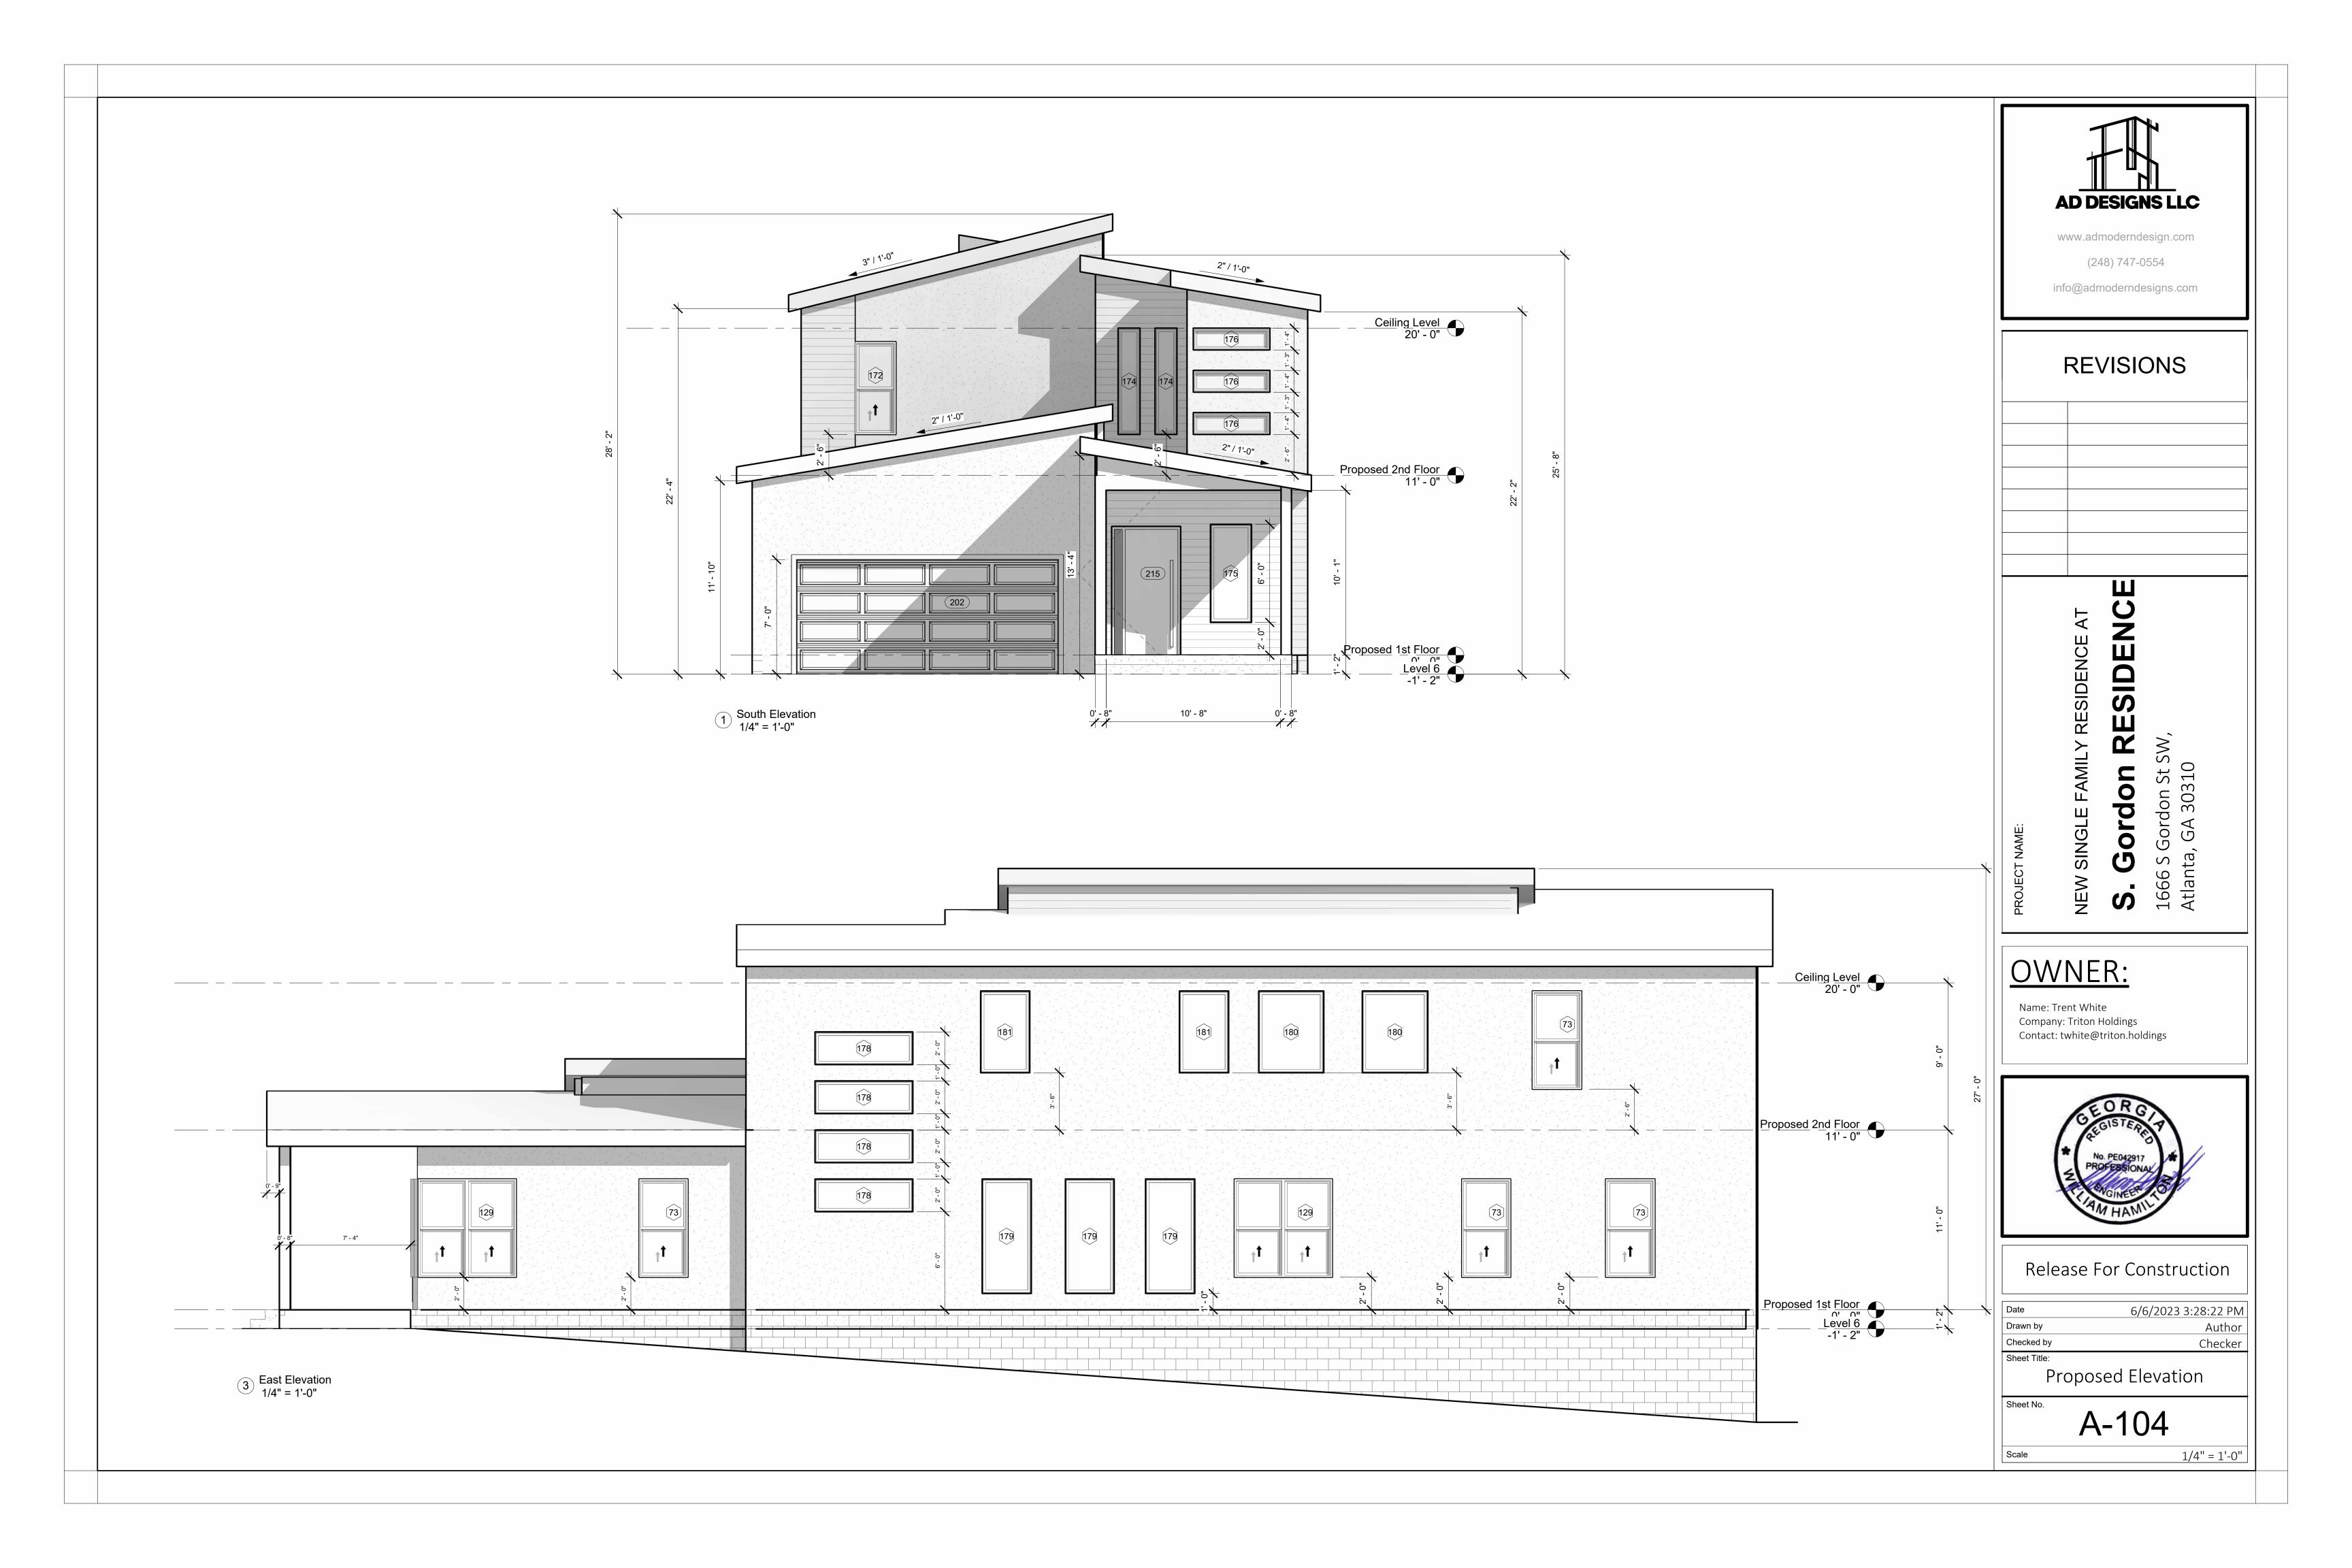
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Proposed 2nd Floor Plan

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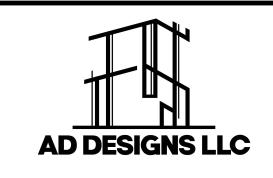
1/4" = 1'-0"



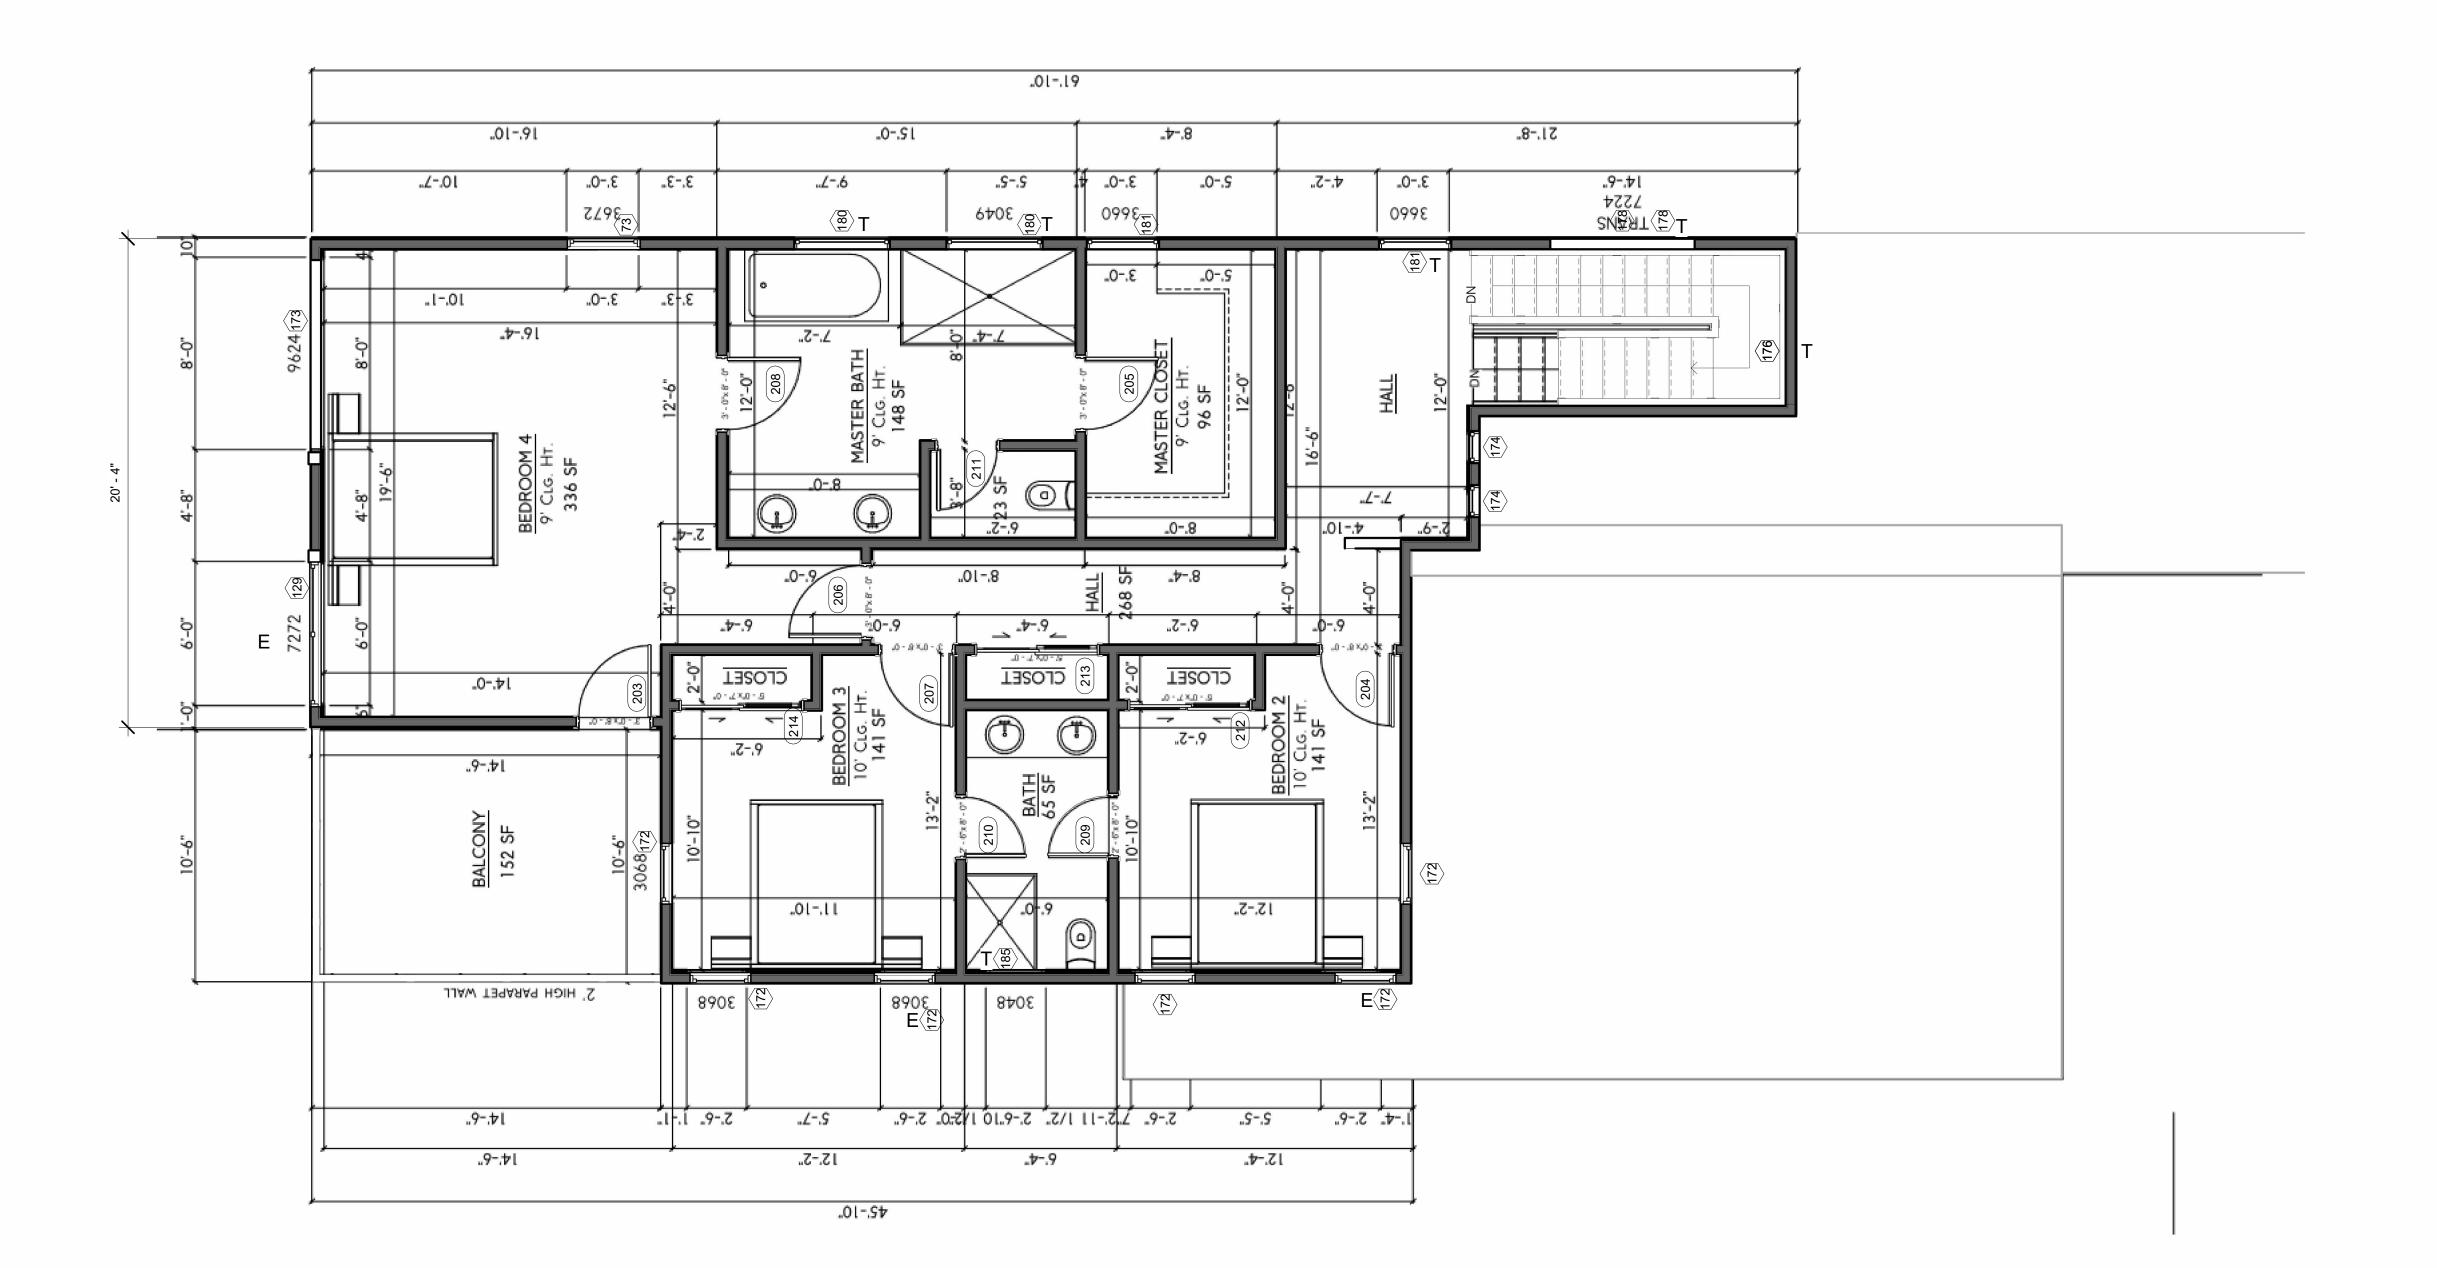

Door Schedule					
Mark	Family and Type	Head Height	Width		
202	Overhead_Sectional_Paneled_Door_15586: 8'-0" x 6'-6"	5' - 10"	16' - 0"		
203	Door-Interior-Single-Full not frame Glass-Wood: 36" x 84"	7' - 0"	3' - 0"		
204	Door-Interior-Single-2 Panel-Wood: 36" x 96"	8' - 0"	3' - 0"		
205	Door-Interior-Single-2_Panel-Wood: 36" x 96"	8' - 0"	3' - 0"		
206	Door-Interior-Single-2_Panel-Wood: 36" x 96"	8' - 0"	3' - 0"		
207	Door-Interior-Single-2_Panel-Wood: 36" x 96"	8' - 0"	3' - 0"		
208	Door-Interior-Single-2_Panel-Wood: 36" x 96"	8' - 0"	3' - 0"		
209	Door-Interior-Single-2_Panel-Wood: 30" x 96"	8' - 0"	2' - 6"		
210	Door-Interior-Single-2_Panel-Wood: 30" x 96"	8' - 0"	2' - 6"		
211	Door-Interior-Single-2_Panel-Wood: 30" x 96"	8' - 0"	2' - 6"		
212	Door-Interior-Double-Sliding-2_Panel-Wood: 60" x 84"	7' - 0"	5' - 0"		
213	Door-Interior-Double-Sliding-2_Panel-Wood: 60" x 84"	7' - 0"	5' - 0"		
214	Door-Interior-Double-Sliding-2_Panel-Wood: 60" x 84"	7' - 0"	5' - 0"		
215	Pivot_Door_Parametric_13011: P/05	10' - 0"	5' - 0"		
216	Door-Interior-Single-Pocket-2_Panel-Wood: 36" x 96"	8' - 0"	3' - 0"		
217	Door-Interior-Single-Pocket-2_Panel-Wood: 36" x 96"	8' - 0"	3' - 0"		
218	Door-Interior-Single-Pocket-2_Panel-Wood: 30" x 96"	8' - 0"	2' - 6"		
219	Door-Interior-Single-Pocket-2_Panel-Wood: 36" x 96"	8' - 0"	3' - 0"		
220	Door-Interior-Single-Pocket-2_Panel-Wood: 28" x 84"	7' - 0"	2' - 4"		
224	Door-Opening: 36" x 84"	0' - 0"	0' - 0"		
225	Door-Exterior-Single-Entry-Half Flat Glass-Wood_Clad: 36" x 96"	8' - 0"	3' - 0"		
226	Door-Interior-Single-2_Panel-Wood: 36" x 96"	8' - 0"	3' - 0"		

	Window Schedule					
Type Mark	Family and Type	Sill Height	Height	Width		
7	Fixed: 24" x 72"	2' - 6"	6' - 0"	2' - 0"		
73	Window-Single-Hung: 36" x 72"	<varies></varies>	6' - 0"	3' - 0"		
129	Window-Single-Hung-Double: 72" x72"	<varies></varies>	6' - 0"	6' - 0"		
172	Window-Single-Hung: 30" x 68"	2' - 6"	5' - 8"	2' - 6"		
173	Fixed: 96" x 24"	6' - 0"	2' - 0"	8' - 0"		
174	Fixed: 16" x 78"	2' - 6"	6' - 6"	1' - 4"		
175	Fixed: 30" x 72"	<varies></varies>	6' - 0"	2' - 6"		
176	Fixed: 48" x 16"	<varies></varies>	1' - 4"	4' - 8"		
178	Fixed: 72" x 24"	<varies></varies>	2' - 0"	6' - 0"		
179	Fixed: 36" x 84"	1' - 0"	7' - 0"	3' - 0"		
180	Fixed: 48" x 60"	3' - 6"	5' - 0"	4' - 0"		
181	Fixed: 36" x 60"	3' - 6"	5' - 0"	3' - 0"		
183	Fixed: 60" x 16"	7' - 0"	1' - 4"	5' - 0"		
184	Window-Single-Hung: 36" x 54"	3' - 7 3/32"	4' - 6"	3' - 0"		
185	Fixed: 30" x 48"	4' - 2"	4' - 0"	2' - 6"		



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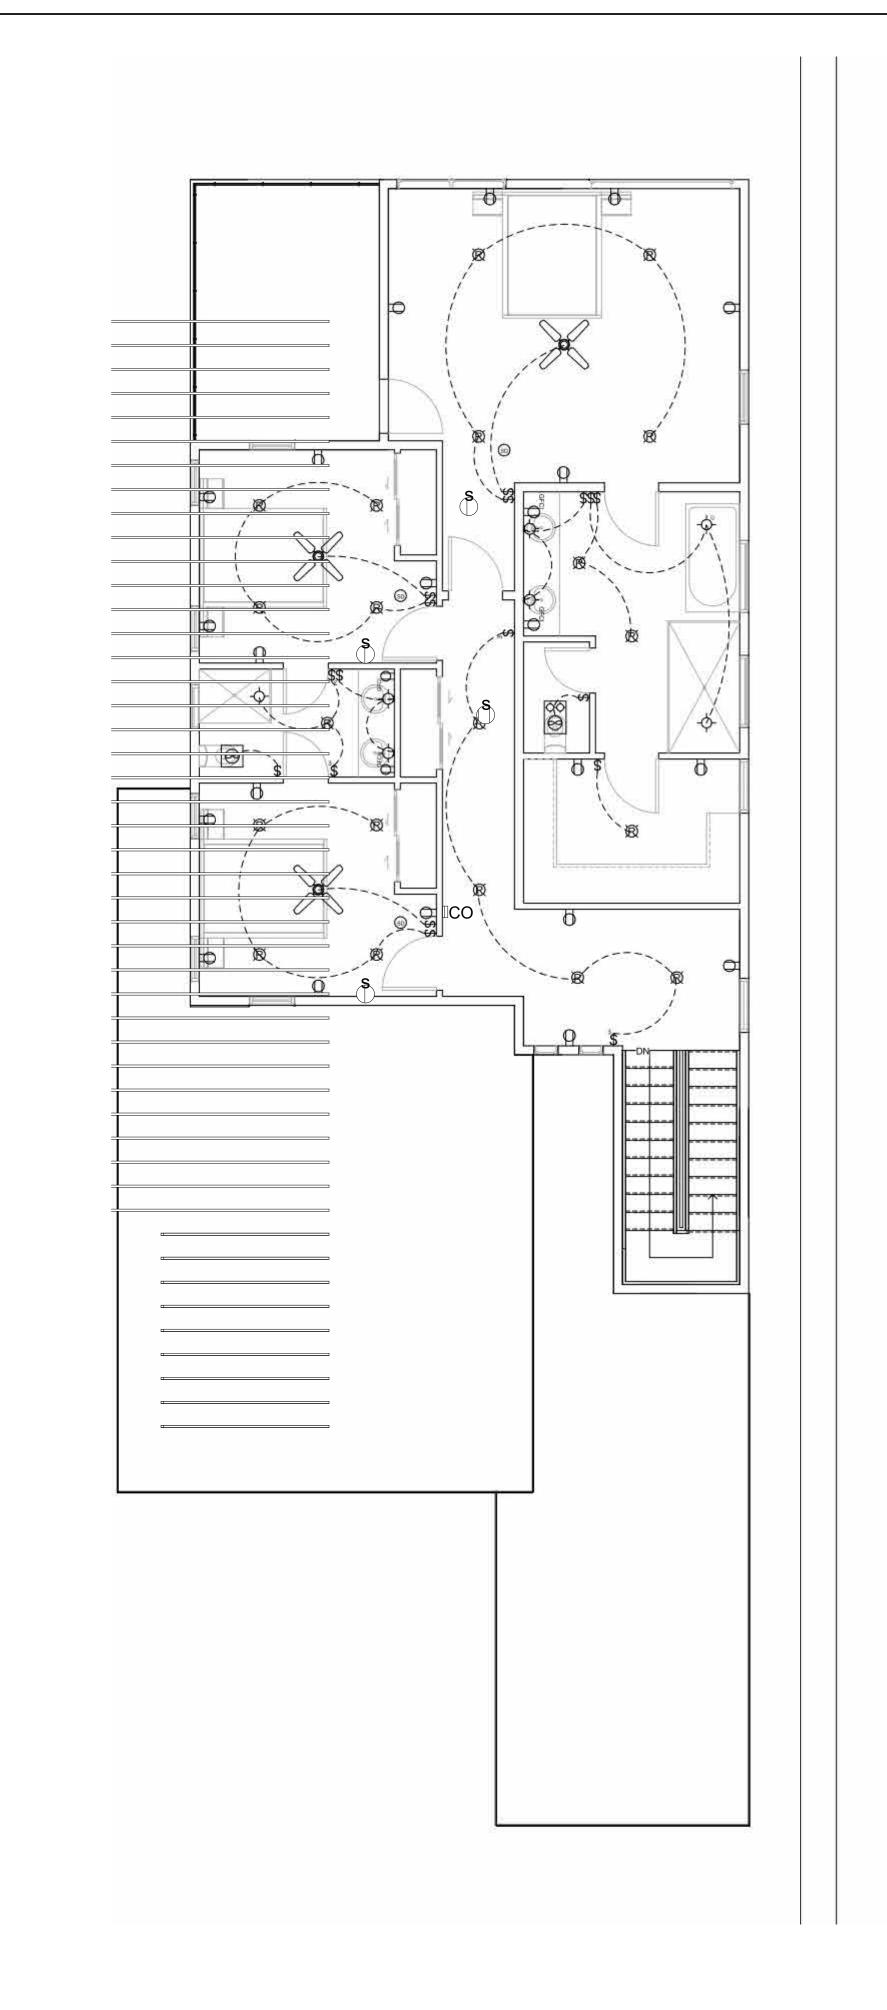
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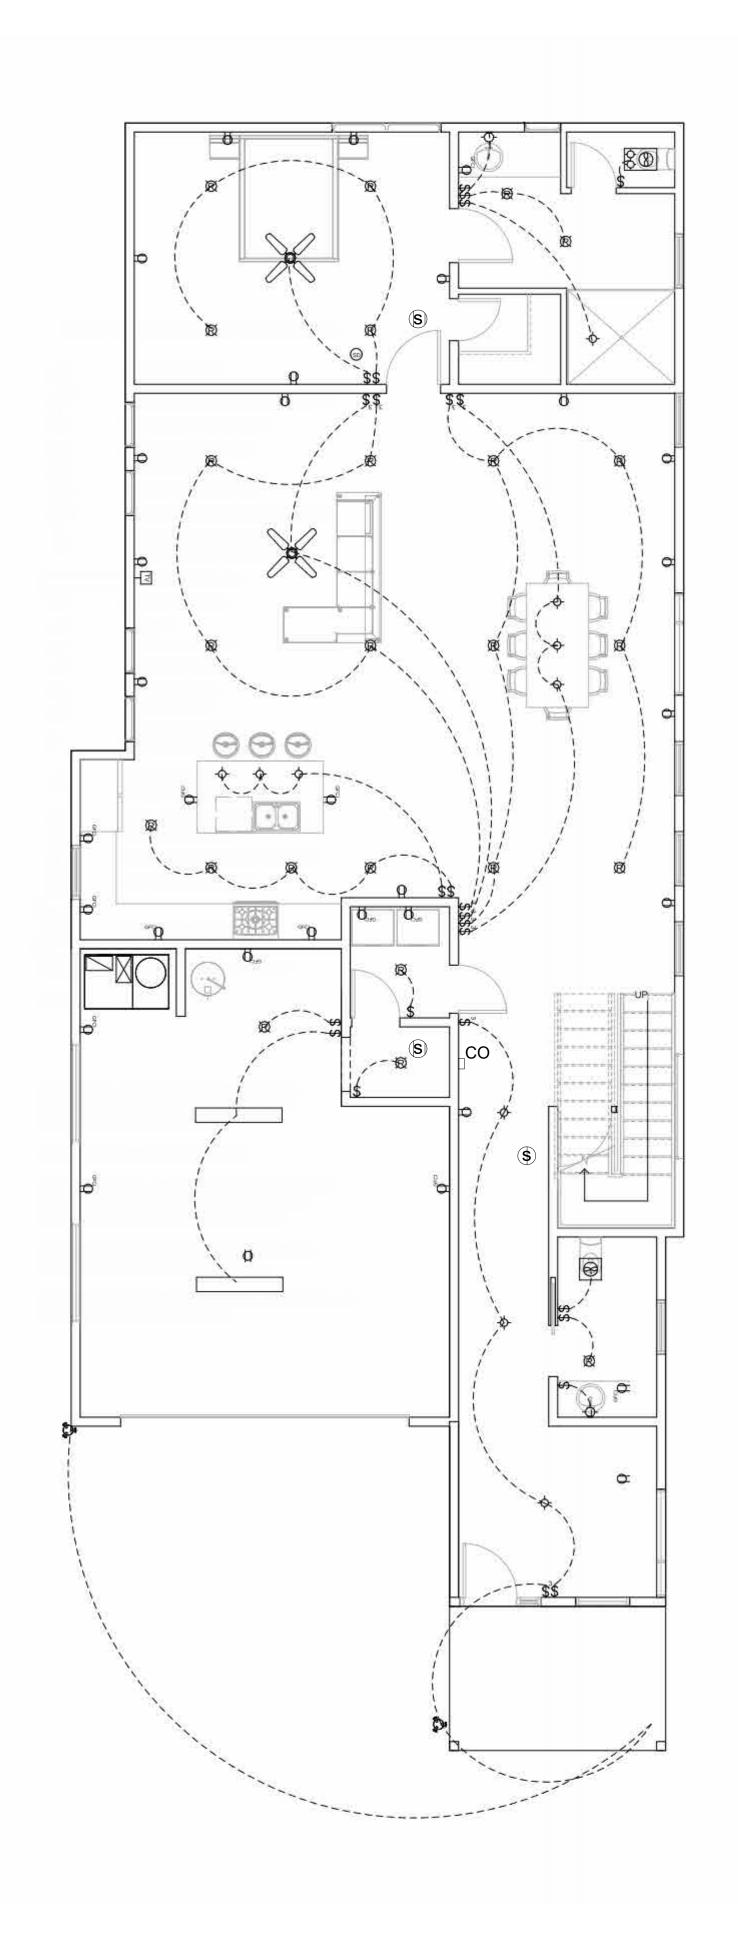
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ELECTRICAL SYMBOLS LEGEND

110 VOLT OUTLET GROUND FAULT PROTECTED OUTLET WEATHERPROOF OUTLET 220 VOLT RECEPTACLE FLOOR OUTLET CEILING HUNG FIXTURE OVERHANG MOUNTED FLOODLIGHTS RECESSED CEILING FIXTURE (VERIFY LOCATIONS W/ OWNER) FLUORESCENT LIGHT SMOKE DETECTOR THREE WAY SWITCH FOUR WAY SWITCH

DIMMER SWITCH TELEPHONE OUTLET (VERIFY LOCATIONS W/ OWNER) TELEVISION OUTLET

(VERIFY LOCATIONS W/ OWNER) WALL MOUNTED LIGHT FIXTURE DOORBELL BUTTON

THERMOSTAT (VERIFY LOCATIONS) CEILING EXHAUST FAN

CEILING FAN W/ LIGHT CEILING EXHAUST FAN W/ LIGHT

WALL SCONCE SMOKE DETECTOR CO DETECTOR

ELECTRICAL CONTRACTOR TO VERIFY ALL EXISTING SITE CONDITIONS & MAKE ANY NECESSARY ADJUSTMENTS.

SMALLEST WIRE SIZE TO BE 12-2.

PER OWNER'S SPECIFICATIONS.

ALL WORK SHALL COMPLY WITH THE NATIONAL ELECTRIC CODE & ANY OTHER APPLICABLE REGULATIONS OR CODES, AT THE SITE.

CONTRACTOR TO LOCATE PHONE, CABLE, ETC. AS

ALL SMOKE DETECTORS TO BE HARD-WIRED TOGETHER WITH BATTERY BACKUP.

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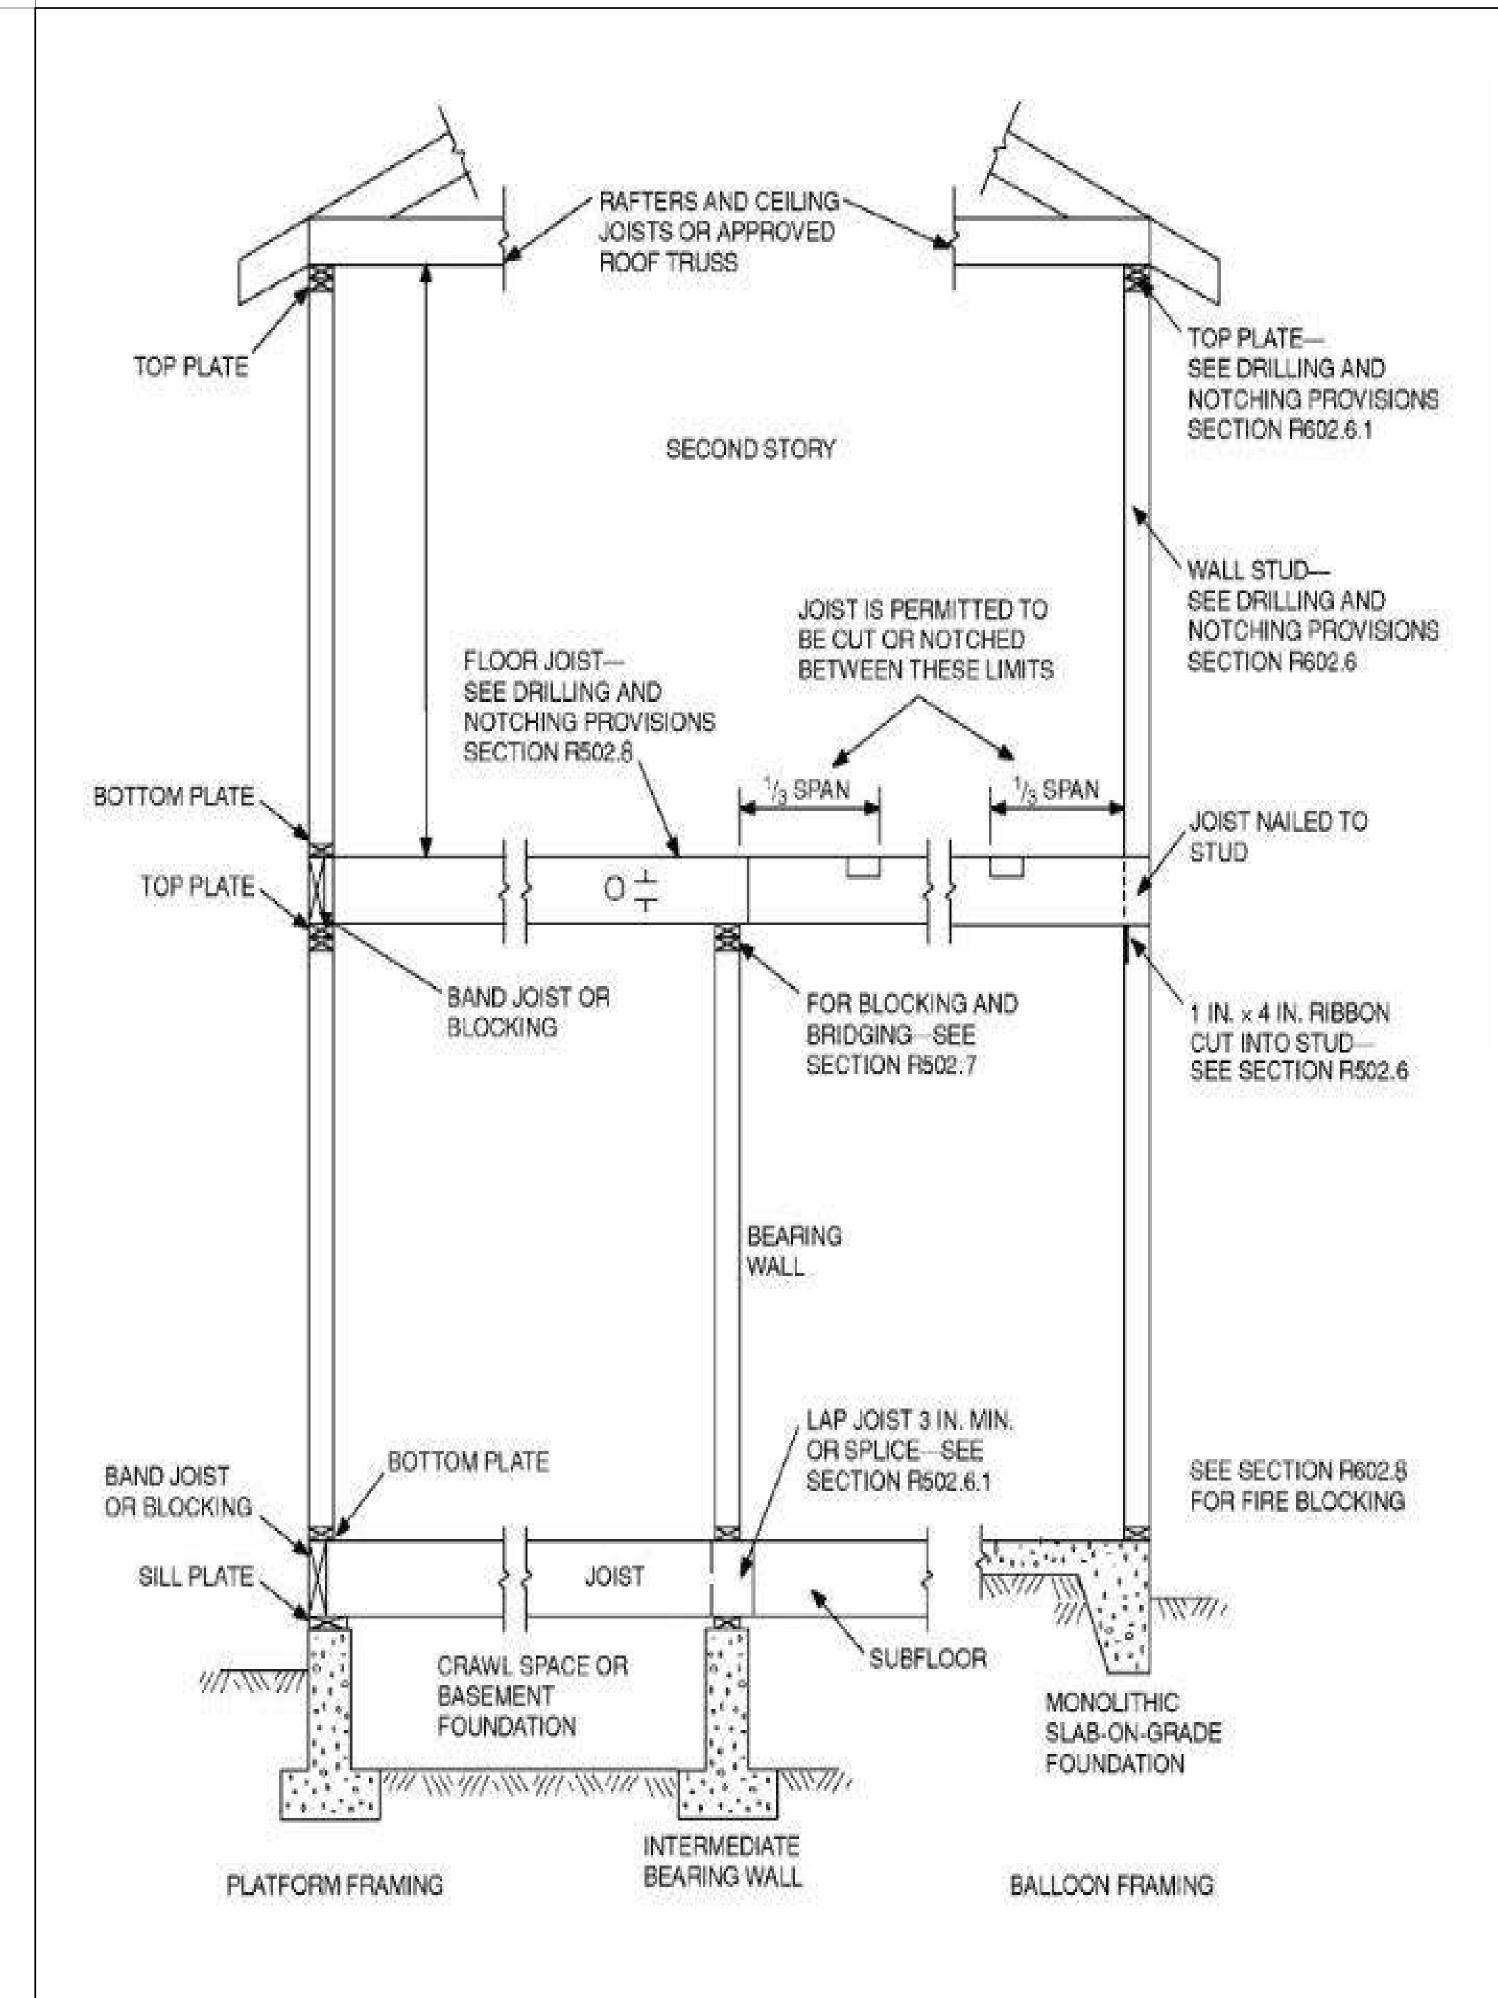
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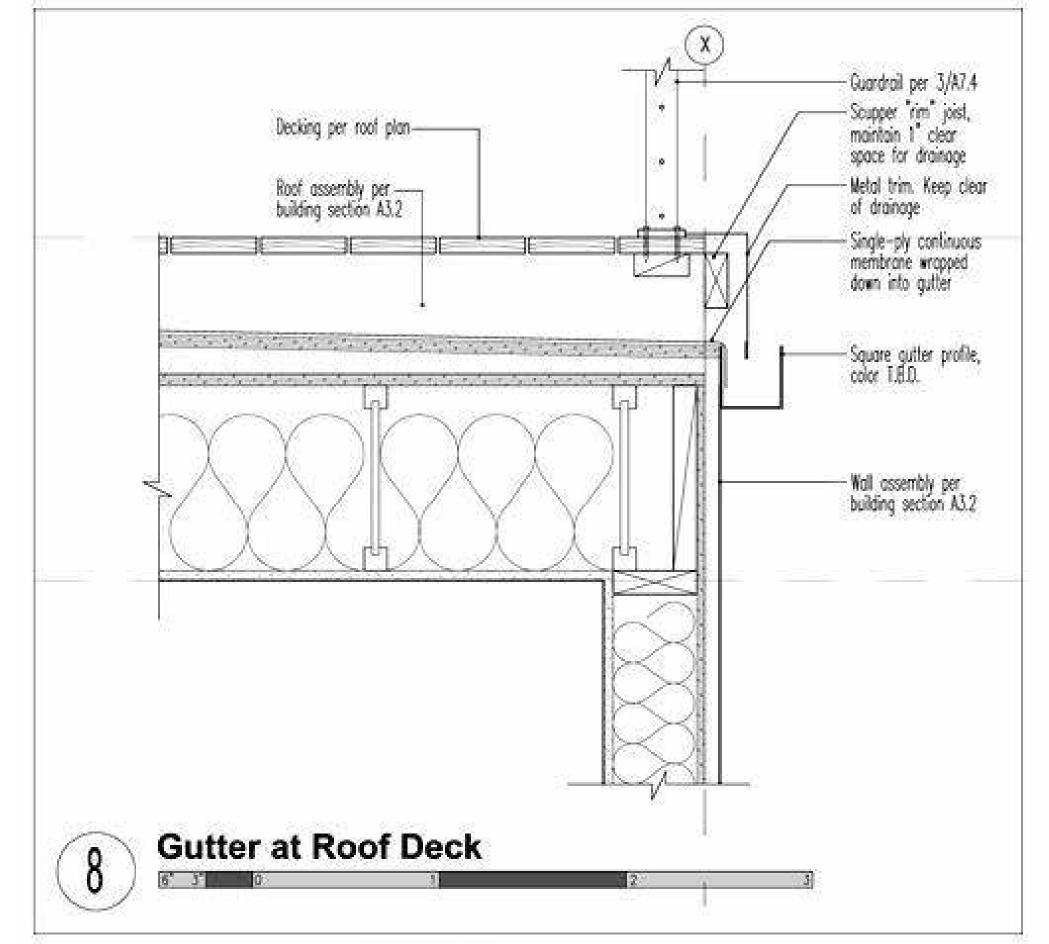
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3/16" = 1'-0"





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Zone	Attics	2x4	2x6	Floors	Crawlspaces
1	R30 to R49	R13 to R15	R19 to R21	R13	R13
2	R30 to R60	R13 to R15	R19 to R21	R13	R13 to R19
3	R30 to R60	R13 to R15	R19 to R21	R25	R19 to R25
4	R38 to R60	R13 to R15	R19 to R21	R25 to R30	R25 to R30
5	R49 to R60	R13 to R15	R19 to R21	R25 to R30	R25 to R30
6	R49 to R60	R13 to R15	R19 to R21	R25 to R30	R25 to R30
7	R49 to R60	R13 to R15	R19 to R21	R25 to R30	R25 to R30



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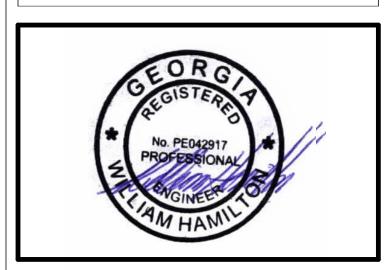
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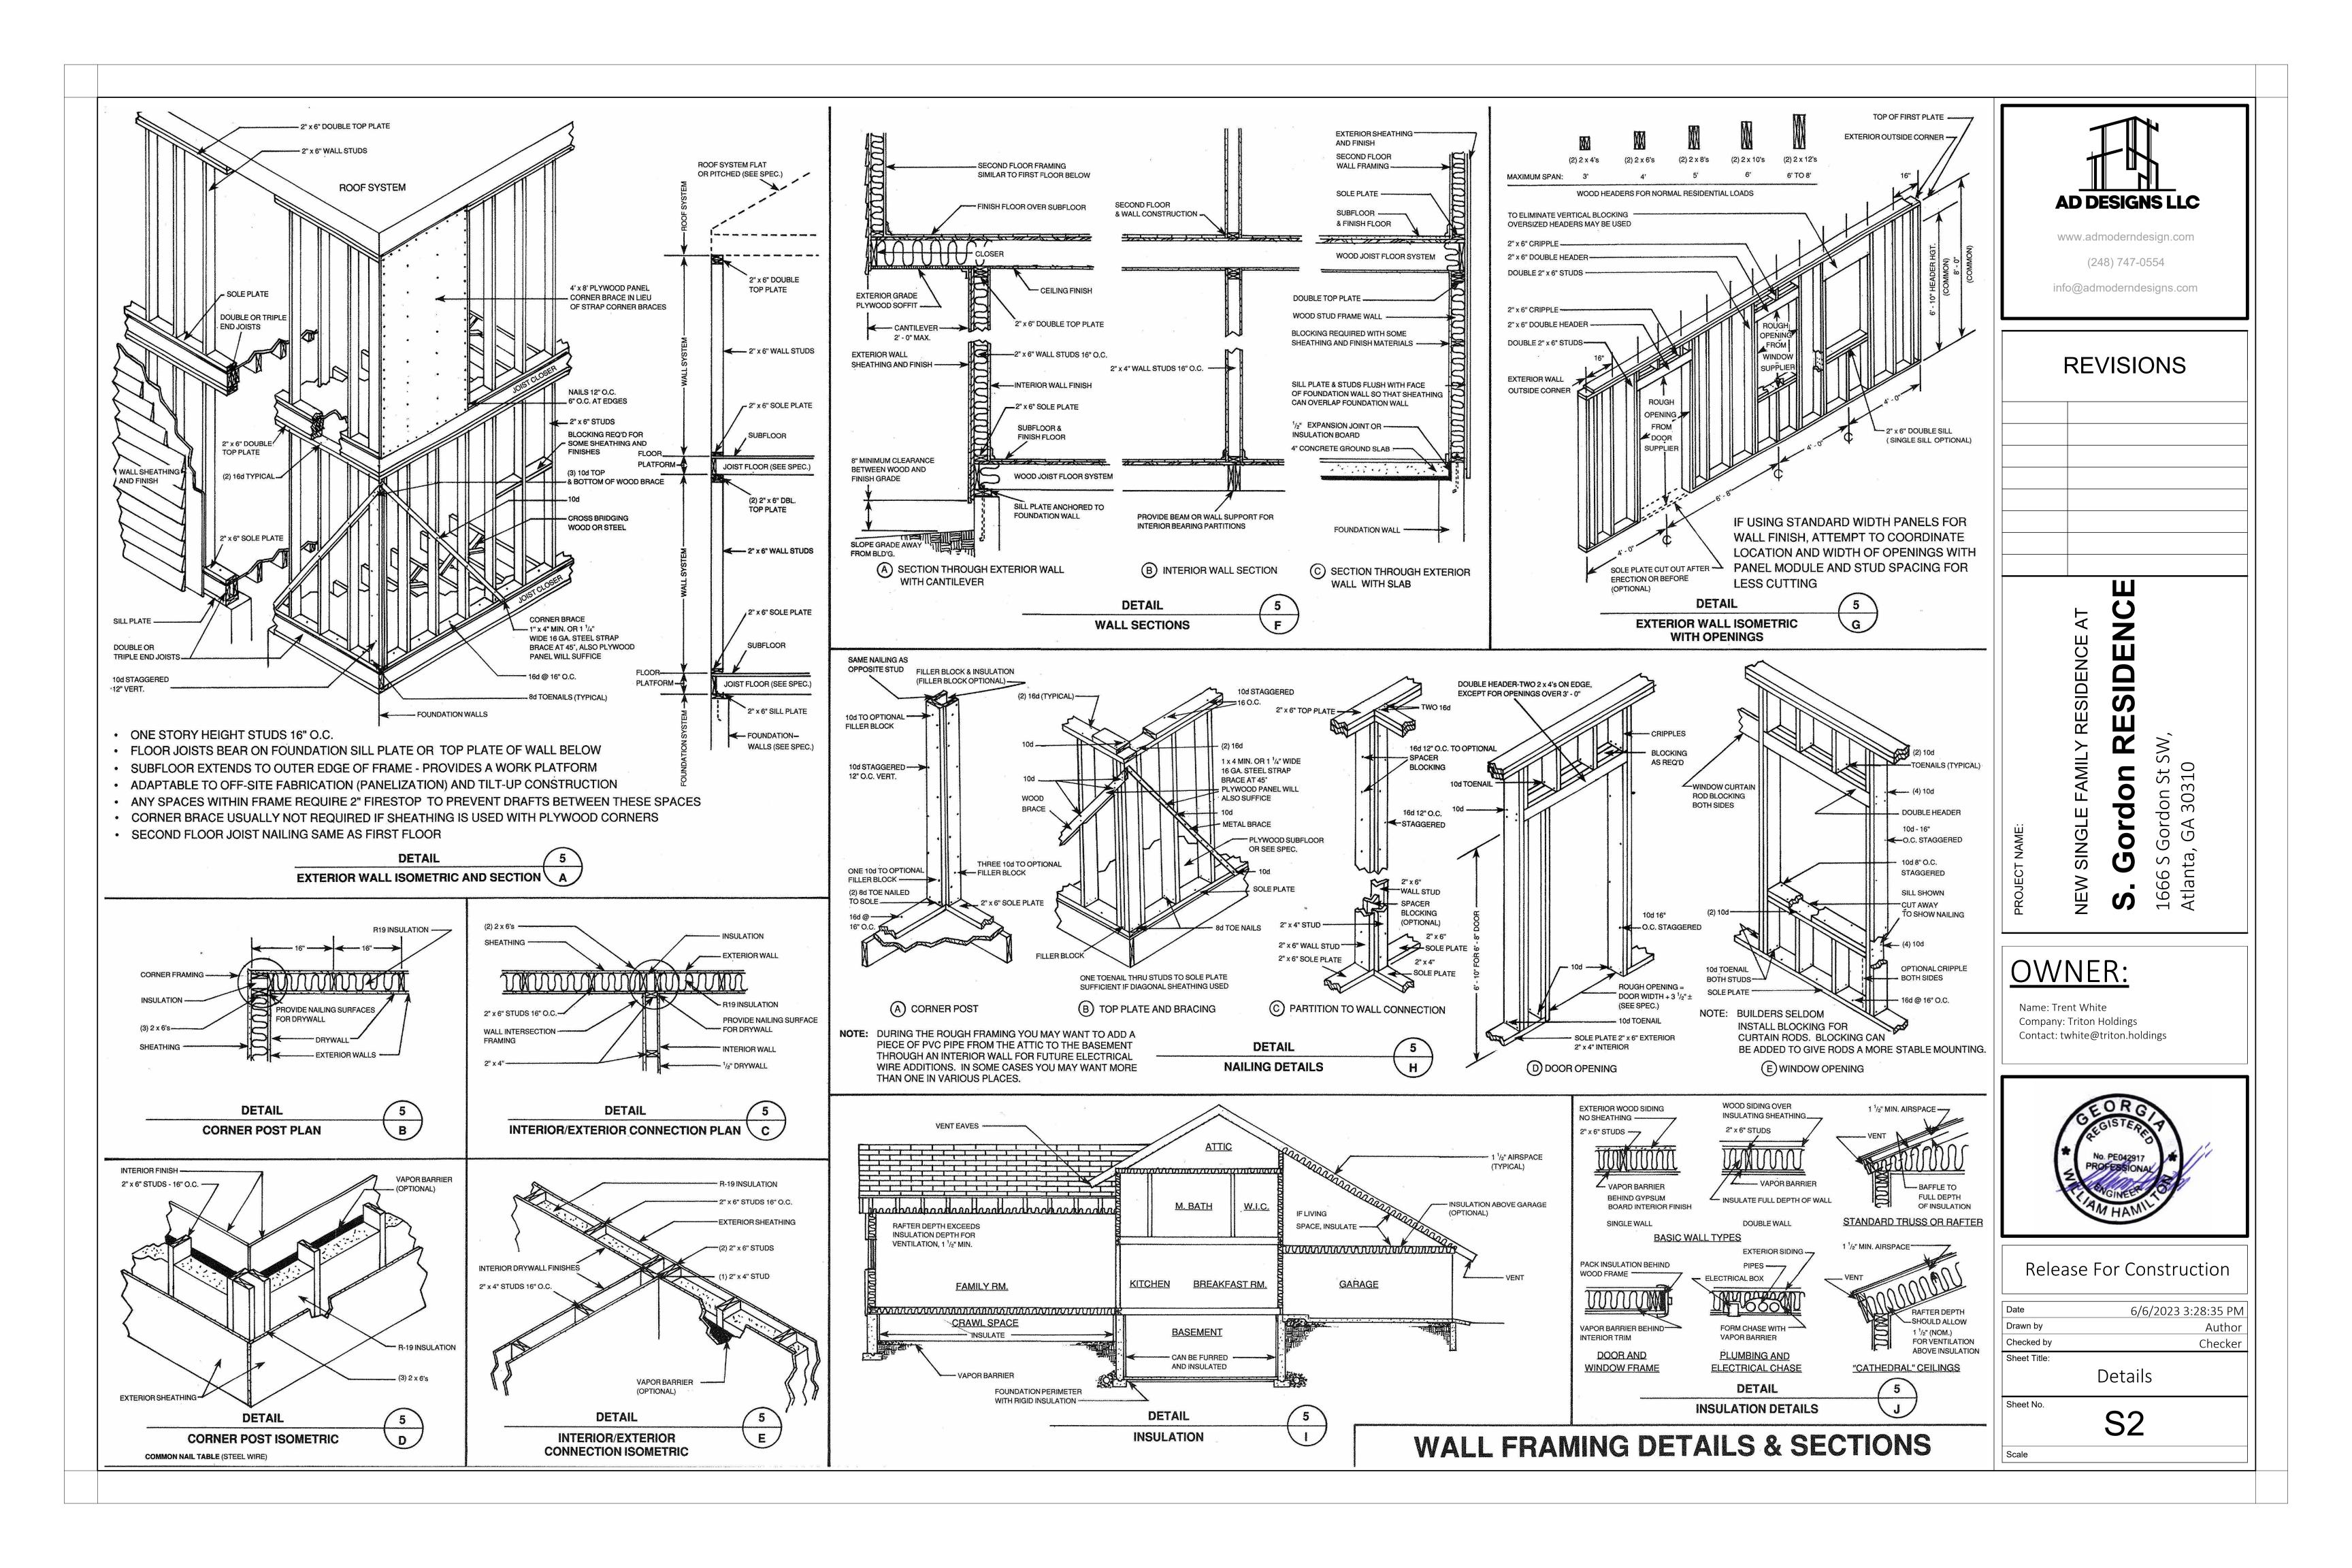
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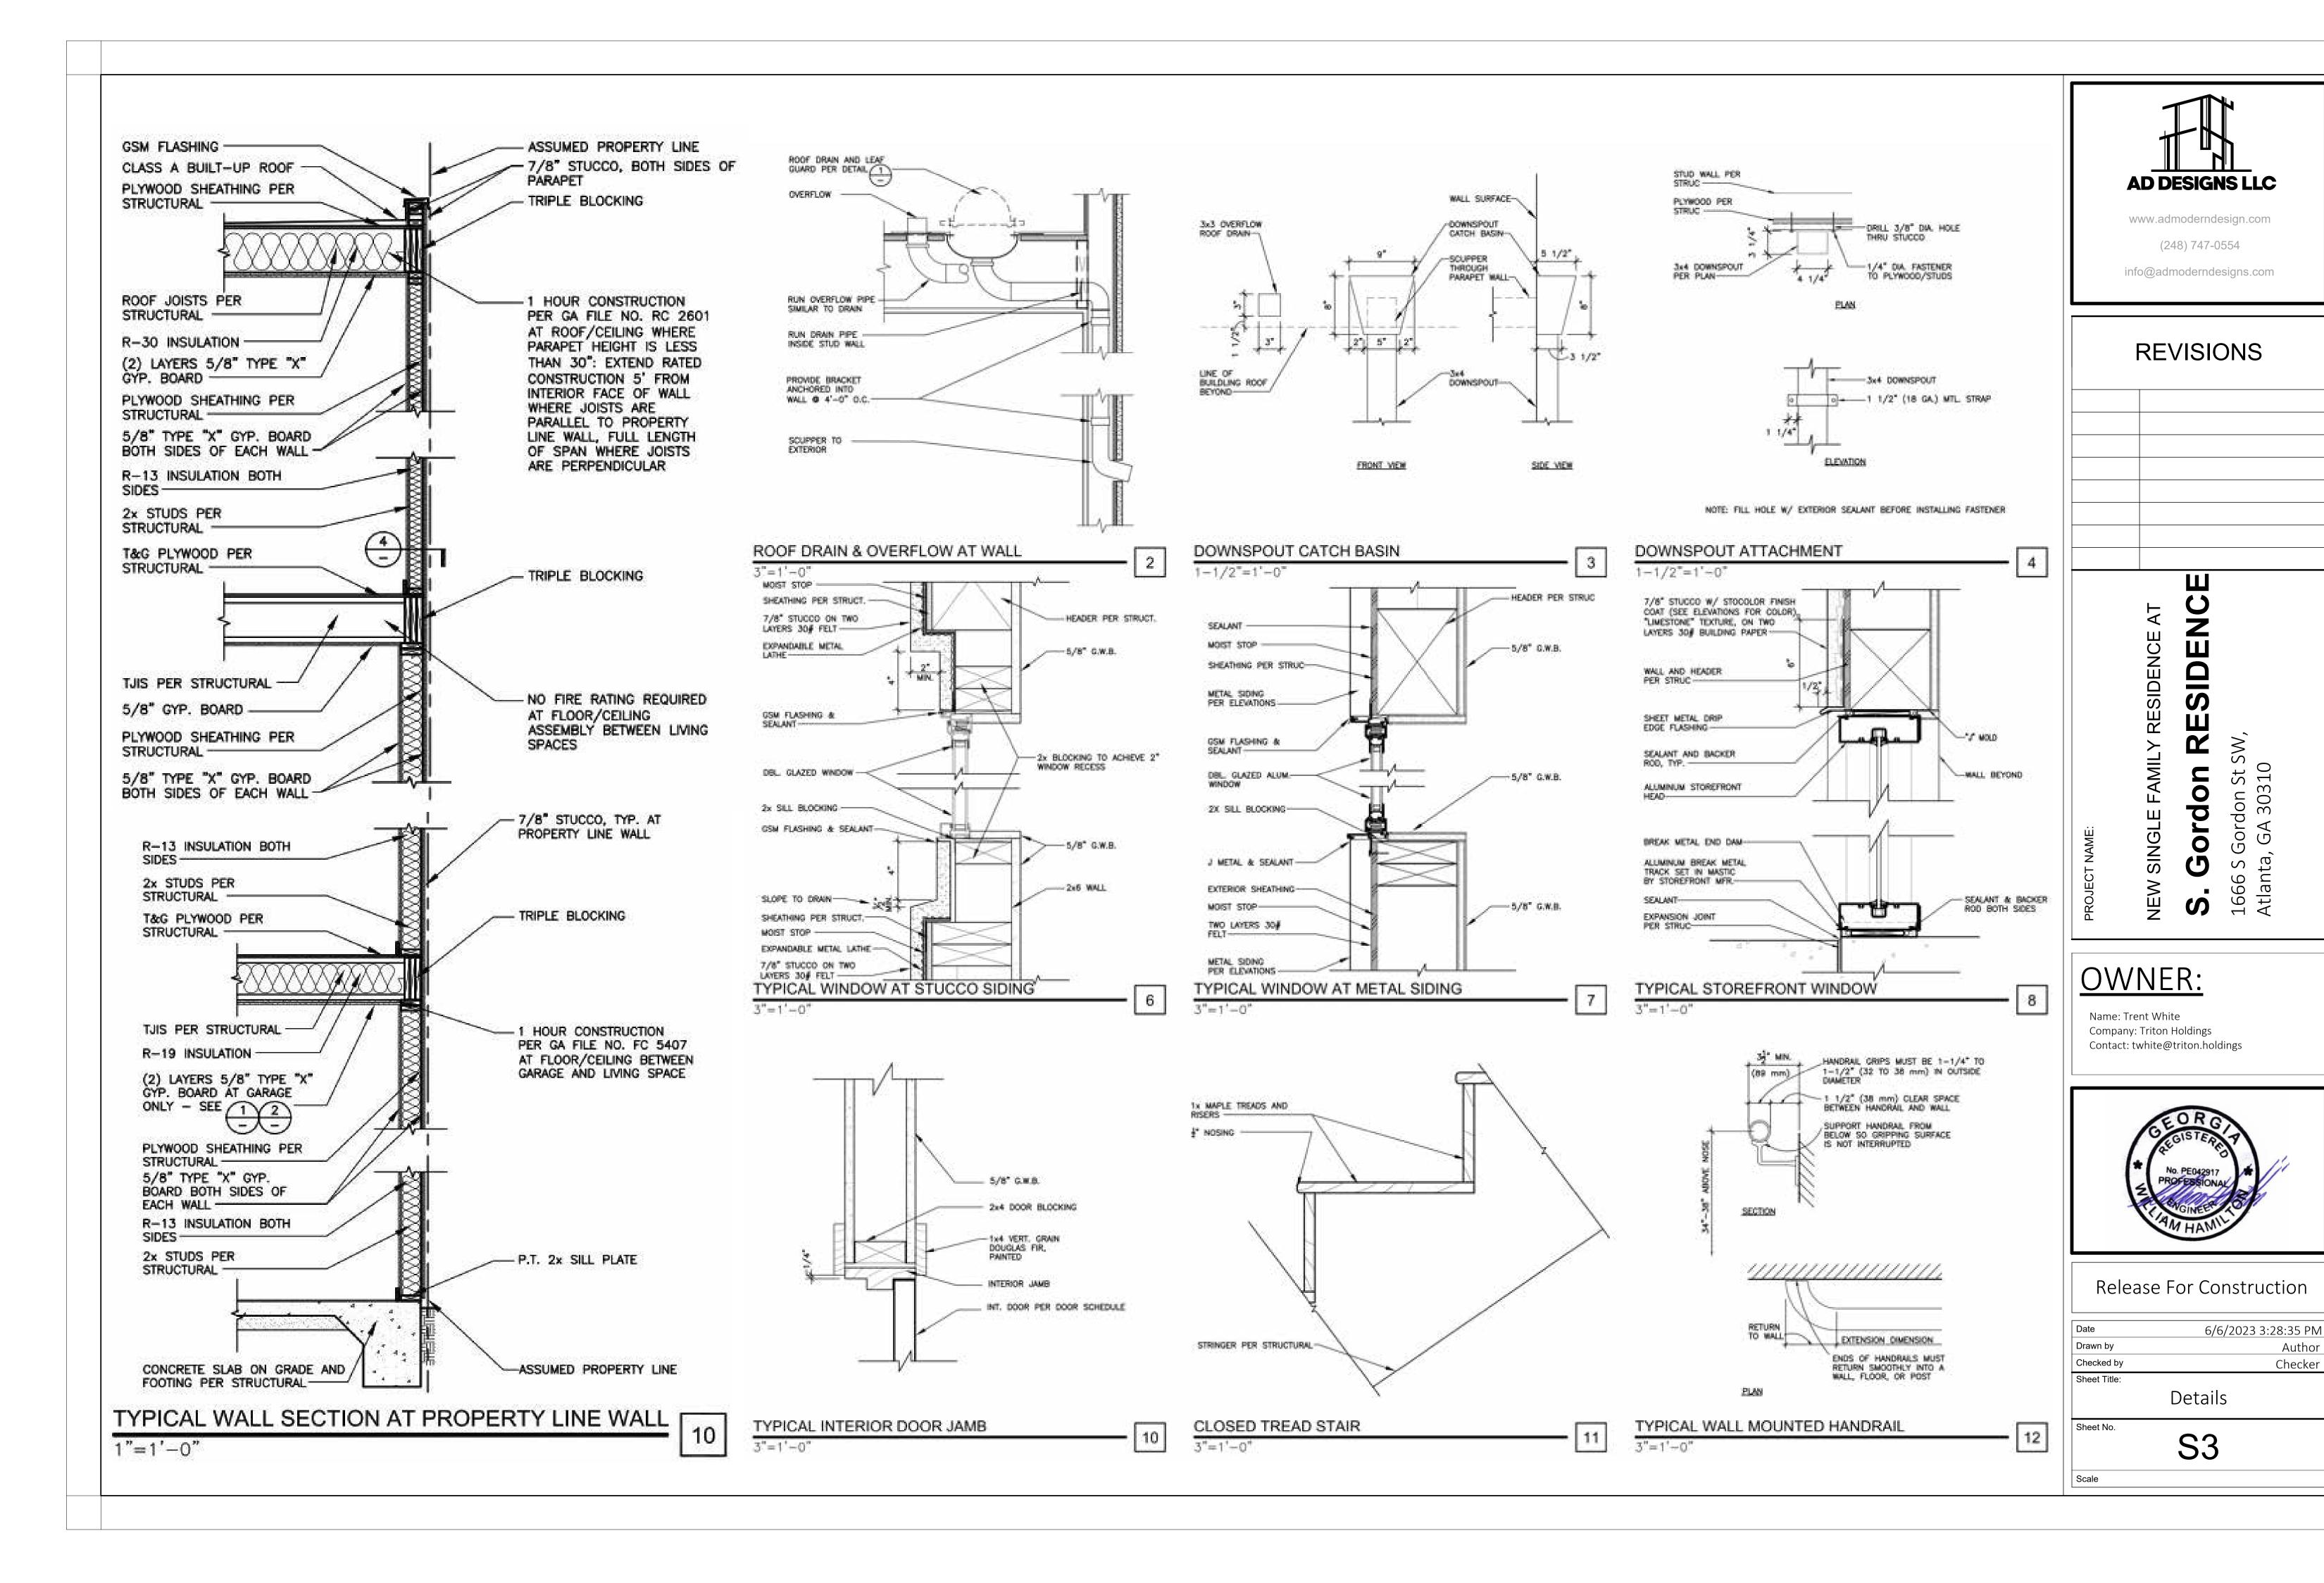


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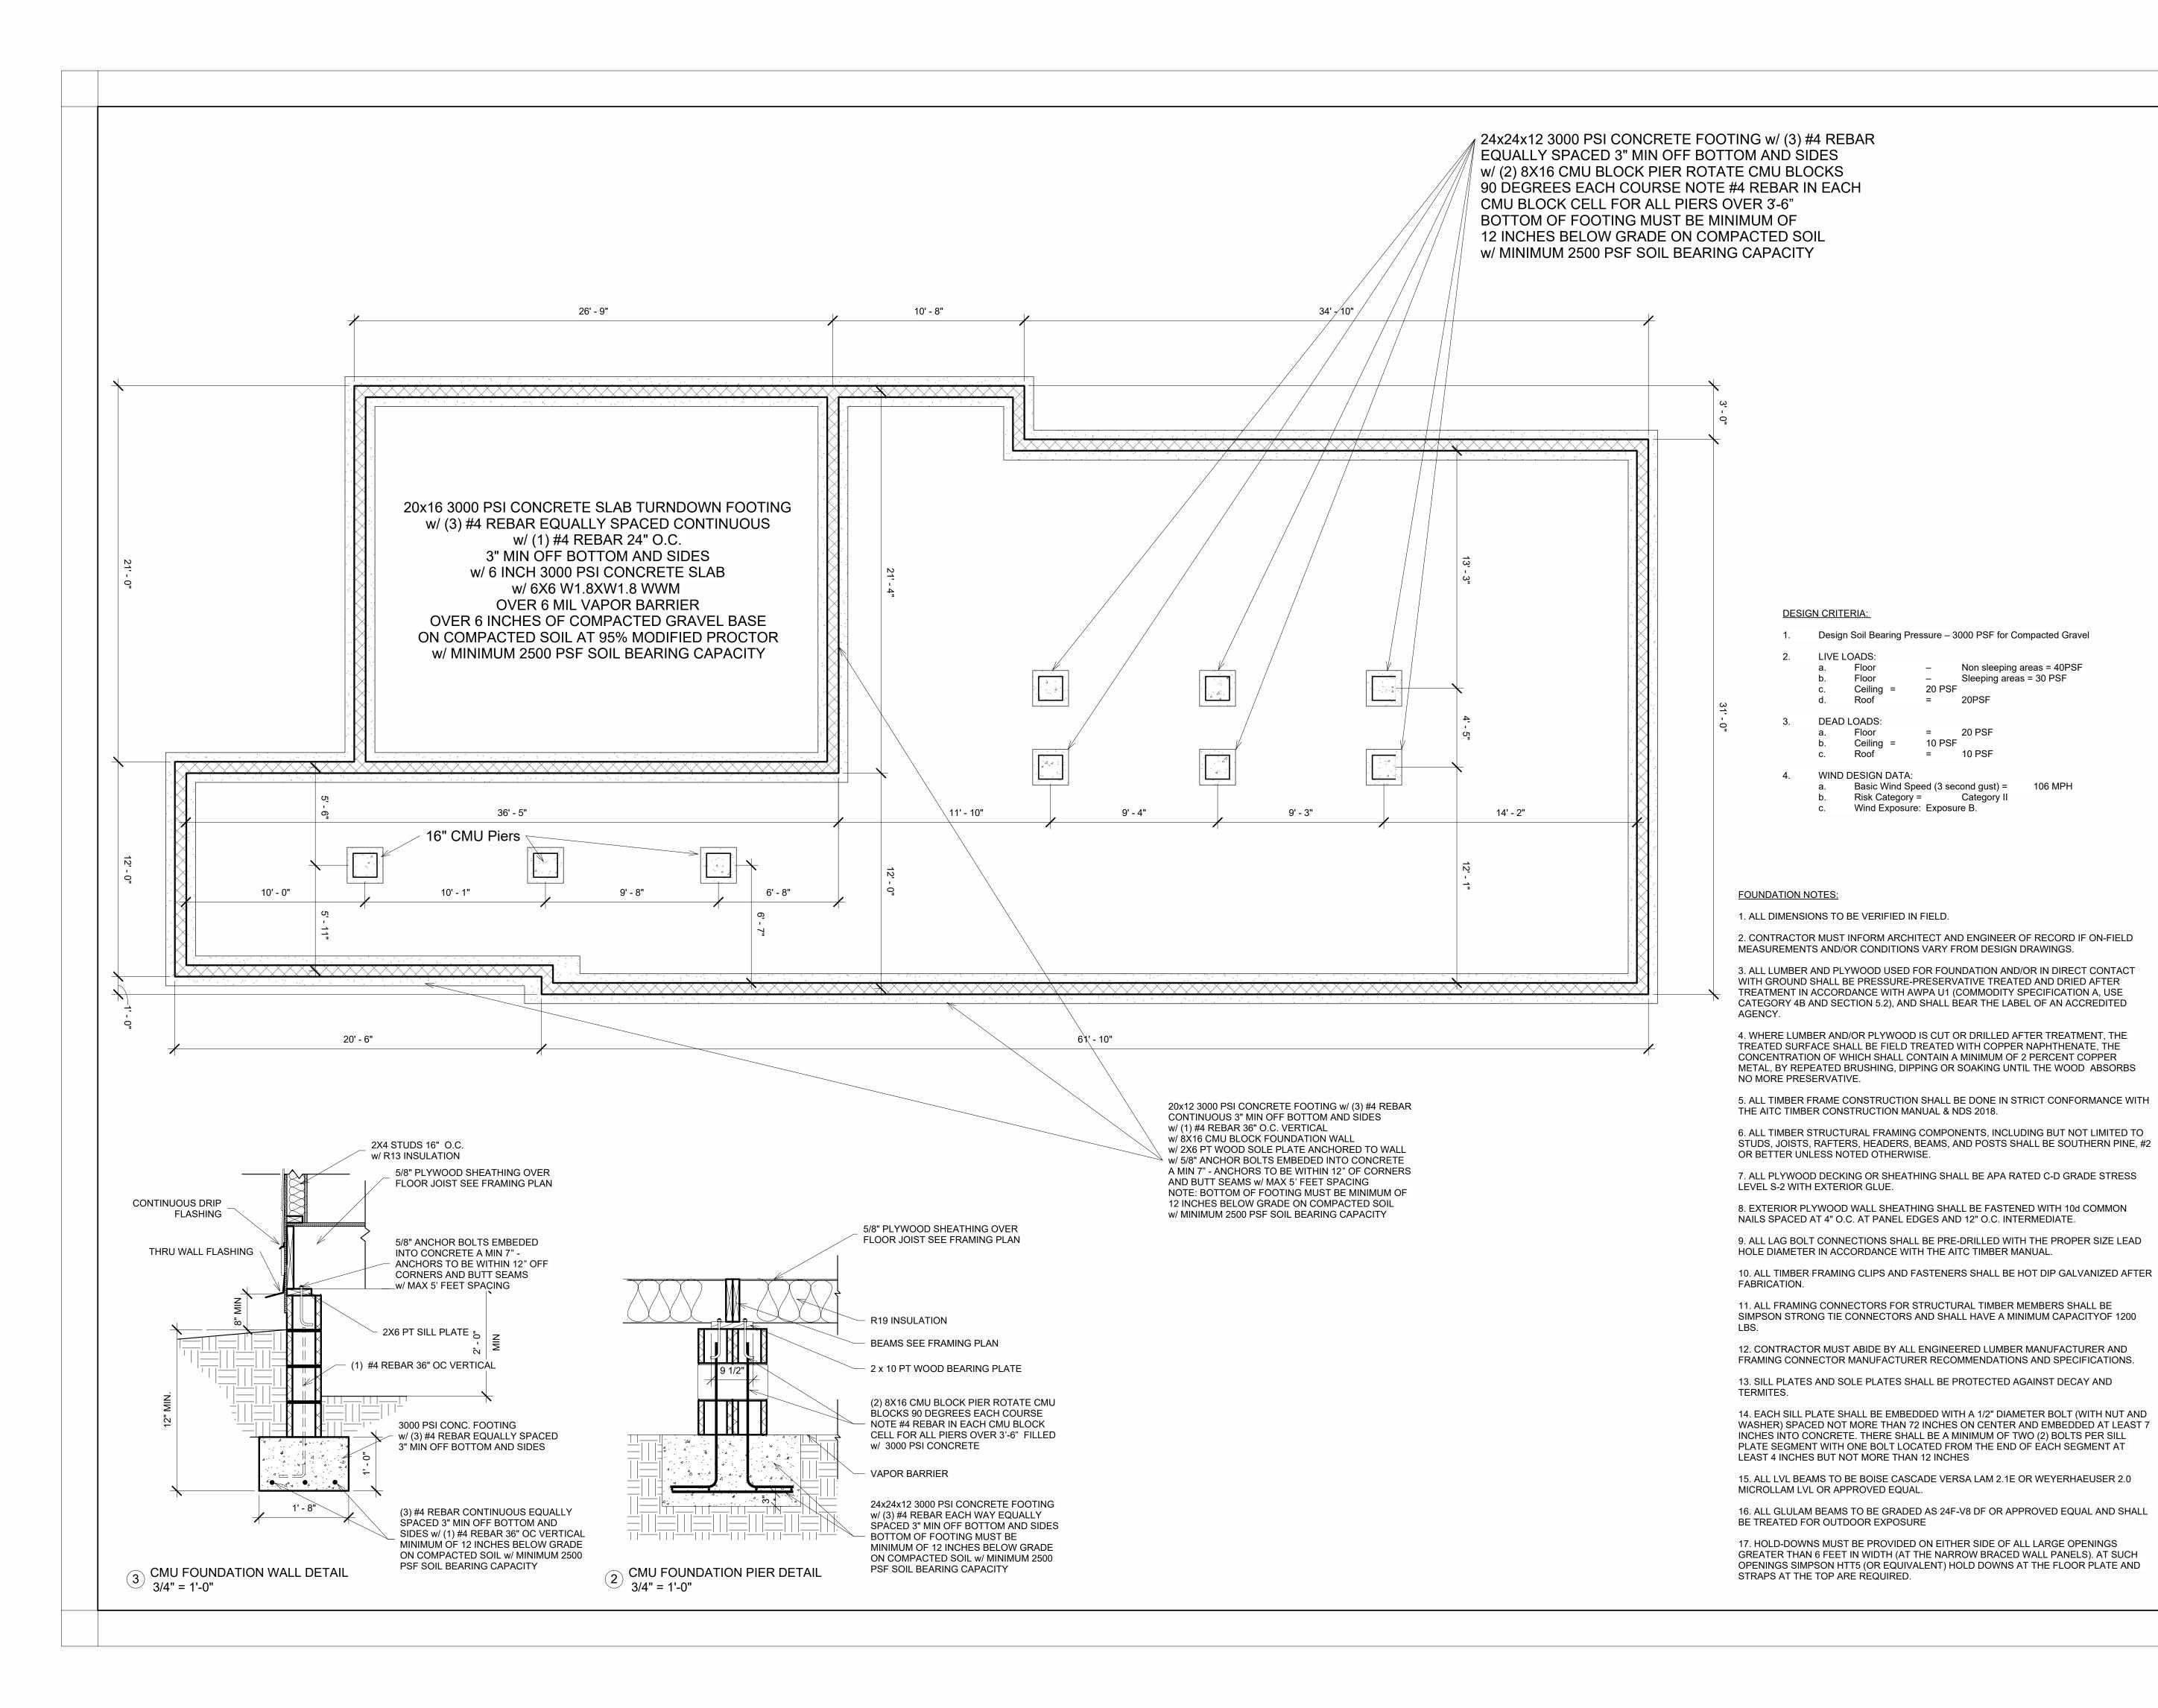
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Non sleeping areas = 40PSF

Sleeping areas = 30 PSF

20 PSF

10 PSF

= 20 PSF

10 PSF

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Release For Construction

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	Foundation Plan	

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Equivalency Chart*


		WOOD	בו כו חר-ו			
I-JOIST	Pacific Woodtech†	Trus Joist	Boise	Roseburg	LP	LPss
	PWI-20	TJI-110	BCI-5000	RFPI-20		LPI-18
Un to 24"	PWI-47	TJI-210/230	BCI-6000/6500	RFPI-40/400	LPI-530	0 LPI-20/32
Up to 24"	PWI-70	TJI-360	BCI-60	RFPI-70	LPI-36 LPI-42	
	PWI-90	TJI-560	BCI-90	RFPI-90	LPI-56	
		STRUCTURAL COM	MPOSITE LUMBER			
BEAM / HEADER	Pacific Woodtech†	Trus Joist	Boise	Roseburg		LP
42/11	LVL (1.6E)	LSL (1.55E)	LVL (1.8E)	LVL (1.6E)	Т	TBD***
1¾"	LVL (2.1E)	LVL (2.0E)	LVL (2.1E)	LVL (2.1E)	LVL	(2.0E)
3½"	LVL (2.1E)	LSL (1.55E)	LSL (1.55E) LVL (1.8E) LVL (2.1E)	T	BD***	
3/2	LVL (2.1E)	PSL (2.0E / 2.2E)	LVL (2.1E)	LVL (2.1E)	LVL	(2.0E)
3½" - 7"	LVL (2.1E / 2.3E**)	PSL (2.0E / 2.2E)	LVL (2.1E)	LVL (2.1E*)	LVL	(2.0E)
DIM DOADD	Pacific Woodtech†	Trus Joist	Boise	Docobuse		LP
RIM BOARD				Roseburg		
1¼" - 1¾"	LVL Rim Board	LSL Rim Board	LVL Rim Board	LVL Rim Board	T	BD***
DIMENSION	Pacific Woodtech†	Trus Joist	Boise	Roseburg		LP
Various Sizes	LVL	LSL	LVL	LVL	Т	BD***
COLUMNS	Pacific Woodtech†	Trus Joist	Boise	Roseburg		LP
Various Sizes	LVL	PSL	LVL	LVL		.VL

Please note: This equivalency chart is intended to provide a reference to similar strength / performance characteristics by respective manufacturers per current (04/2017) regional

ubstitutions are subject to a review committee, which may include the project structural engineer.

- ** 2.3E, a limited stock item, is available upon request. ** LSL has been discontinued by LP and is no longer available
- † Code reports for Pacific Woodtech Corporation: I-joist (ESR-1225); LVL (ESR-2909)

- **FRAMING NOTES:**
- 1. ALL DIMENSIONS TO BE VERIFIED IN FIELD.
- CONTRACTOR MUST INFORM ARCHITECT AND ENGINEER OF RECORD IF ON-FIELD MEASUREMENTS AND/OR CONDITIONS VARY FROM DESIGN DRAWINGS.
- 3. ALL LUMBER AND PLYWOOD USED FOR FOUNDATION AND/OR IN DIRECT CONTACT WITH GROUND SHALL BE PRESSURE-PRESERVATIVE TREATED AND DRIED AFTER TREATMENT IN ACCORDANCE WITH AWPA U1 (COMMODITY SPECIFICATION A, USE CATEGORY 4B AND SECTION 5.2), AND SHALL BEAR THE LABEL OF AN ACCREDITED AGENCY.
- 4. WHERE LUMBER AND/OR PLYWOOD IS CUT OR DRILLED AFTER TREATMENT, THE TREATED SURFACE SHALL BE FIELD TREATED WITH COPPER NAPHTHENATE, THE CONCENTRATION OF WHICH SHALL CONTAIN A MINIMUM OF 2 PERCENT COPPER METAL, BY REPEATED BRUSHING, DIPPING OR SOAKING UNTIL THE WOOD ABSORBS NO MORE PRESERVATIVE.
- 5. ALL TIMBER FRAME CONSTRUCTION SHALL BE DONE IN STRICT CONFORMANCE WITH THE AITC TIMBER CONSTRUCTION MANUAL & NDS 2012.
- 6. ALL TIMBER STRUCTURAL FRAMING COMPONENTS, INCLUDING BUT NOT LIMITED TO STUDS, JOISTS, RAFTERS, HEADERS, BEAMS, AND POSTS SHALL BE SOUTHERN PINE, #2 OR BETTER UNLESS NOTED OTHERWISE.
- 7. ALL PLYWOOD DECKING OR SHEATHING SHALL BE APA RATED C-D GRADE STRESS LEVEL S-2 WITH EXTERIOR GLUE.
- 8. EXTERIOR PLYWOOD WALL SHEATHING SHALL BE FASTENED WITH 10d COMMON NAILS SPACED AT 4" O.C. AT PANEL EDGES AND 12" O.C. INTERMEDIATE.
- 9. ALL LAG BOLT CONNECTIONS SHALL BE PRE-DRILLED WITH THE PROPER SIZE LEAD HOLE DIAMETER IN ACCORDANCE WITH THE AITC TIMBER MANUAL.
- 10. ALL TIMBER FRAMING CLIPS AND FASTENERS SHALL BE HOT DIP GALVANIZED AFTER FABRICATION.
- 11. ALL FRAMING CONNECTORS FOR STRUCTURAL TIMBER MEMBERS SHALL BE SIMPSON STRONG TIE CONNECTORS AND SHALL HAVE A MINIMUM CAPACITY OF 1100 LBS.
- 12. CONTRACTOR MUST ABIDE BY ALL ENGINEERED LUMBER MANUFACTURER. I-JOIST MANUFACTURER. AND FRAMING CONNECTOR MANUFACTURER RECOMMENDATIONS AND SPECIFICATIONS.
- 13. SILL PLATES AND SOLE PLATES SHALL BE PROTECTED AGAINST DECAY AND TERMITES.
- 14. EACH SILL PLATE SHALL BE EMBEDDED WITH A 1/2" DIAMETER BOLT (WITH NUT AND WASHER) SPACED NOT MORE THAN 72 INCHES ON CENTER AND EMBEDDED AT LEAST 7 INCHES INTO CONCRETE. THERE SHALL BE A MINIMUM OF TWO (2) BOLTS PER SILL PLATE SEGMENT WITH ONE BOLT LOCATED FROM THE END OF EACH SEGMENT AT LEAST 4 INCHES BUT NOT MORE THAN 12 INCHES
- 15. PRE-ENGINEERED TRUSSES SHALL BE DESIGNED BY A PROFESSIONAL ENGINEER REGISTERED IN THE STATE OF GEORGIA
- 16. ALL LVL BEAMS TO BE BOISE CASCADE VERSA LAM 2.1E 3100 Fb
- 17. ALL GLULAM BEAMS TO BE GRADED AS 24F-V4 AND SHALL BE TREATED FOR OUTDOOR EXPOSURE
- 18. HOLD-DOWNS MUST BE PROVIDED ON EITHER SIDE OF ALL LARGE OPENINGS GREATER THAN 6 FEET IN WIDTH (AT THE NARROW BRACED WALL PANELS). AT SUCH OPENINGS SIMPSON HTT5 (OR EQUIVALENT) HOLD DOWNS AT THE FLOOR PLATE AND STRAPS AT THE TOP ARE REQUIRED.

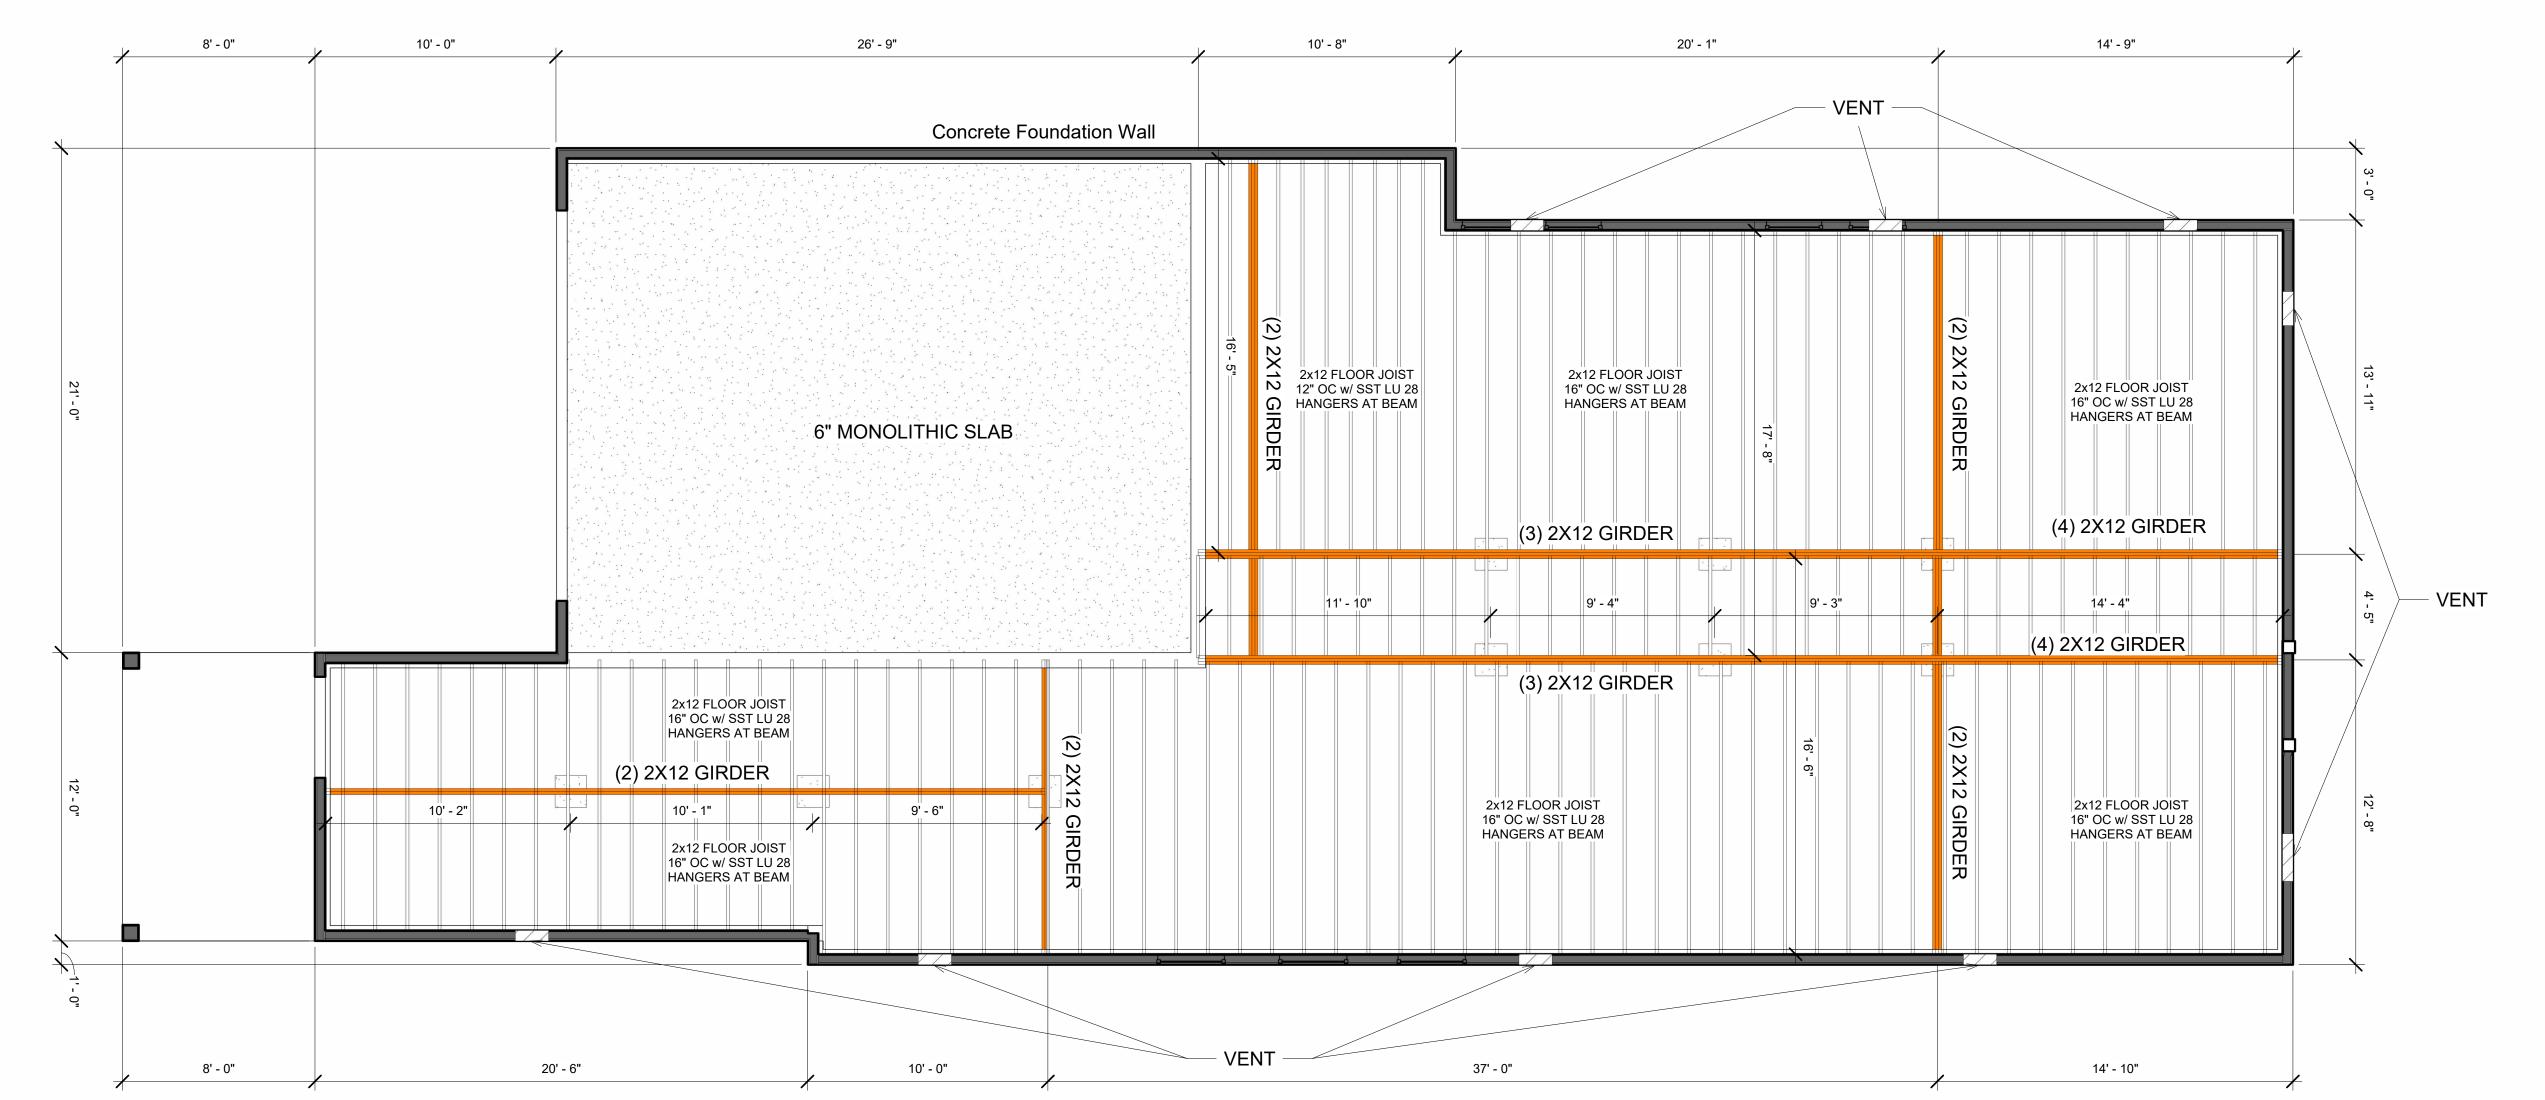



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Sheet Title:	
1st Floor	Framing Plan

Sheet No. **S101**


Scale

1/4" = 1'-0"

DOUBLE 2X8 TOP PLATE 2X8 WALL STUD SPACED AT JOIST SPACING PLANS FOR SIZES PLANS FOR SIZES 2X8 PT SILL PLATE WITH 5/8* DIA. ANCHOR BOLTS EMBEDDED INTO CONCRETE A MIN 7* - ANCHORS TO BE WITHIN 12* OF CORNERS AND BUTT BOLTS EMBEDDED INTO CONCRETE AM 7* - ANCHORS TO BE WITHIN 12* OF CORNERS AND BUTT SEAMS W/ MAX 5* FEET SPACING W/ MAX 5* FEET SPACING

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Gordon RE

OWNER:

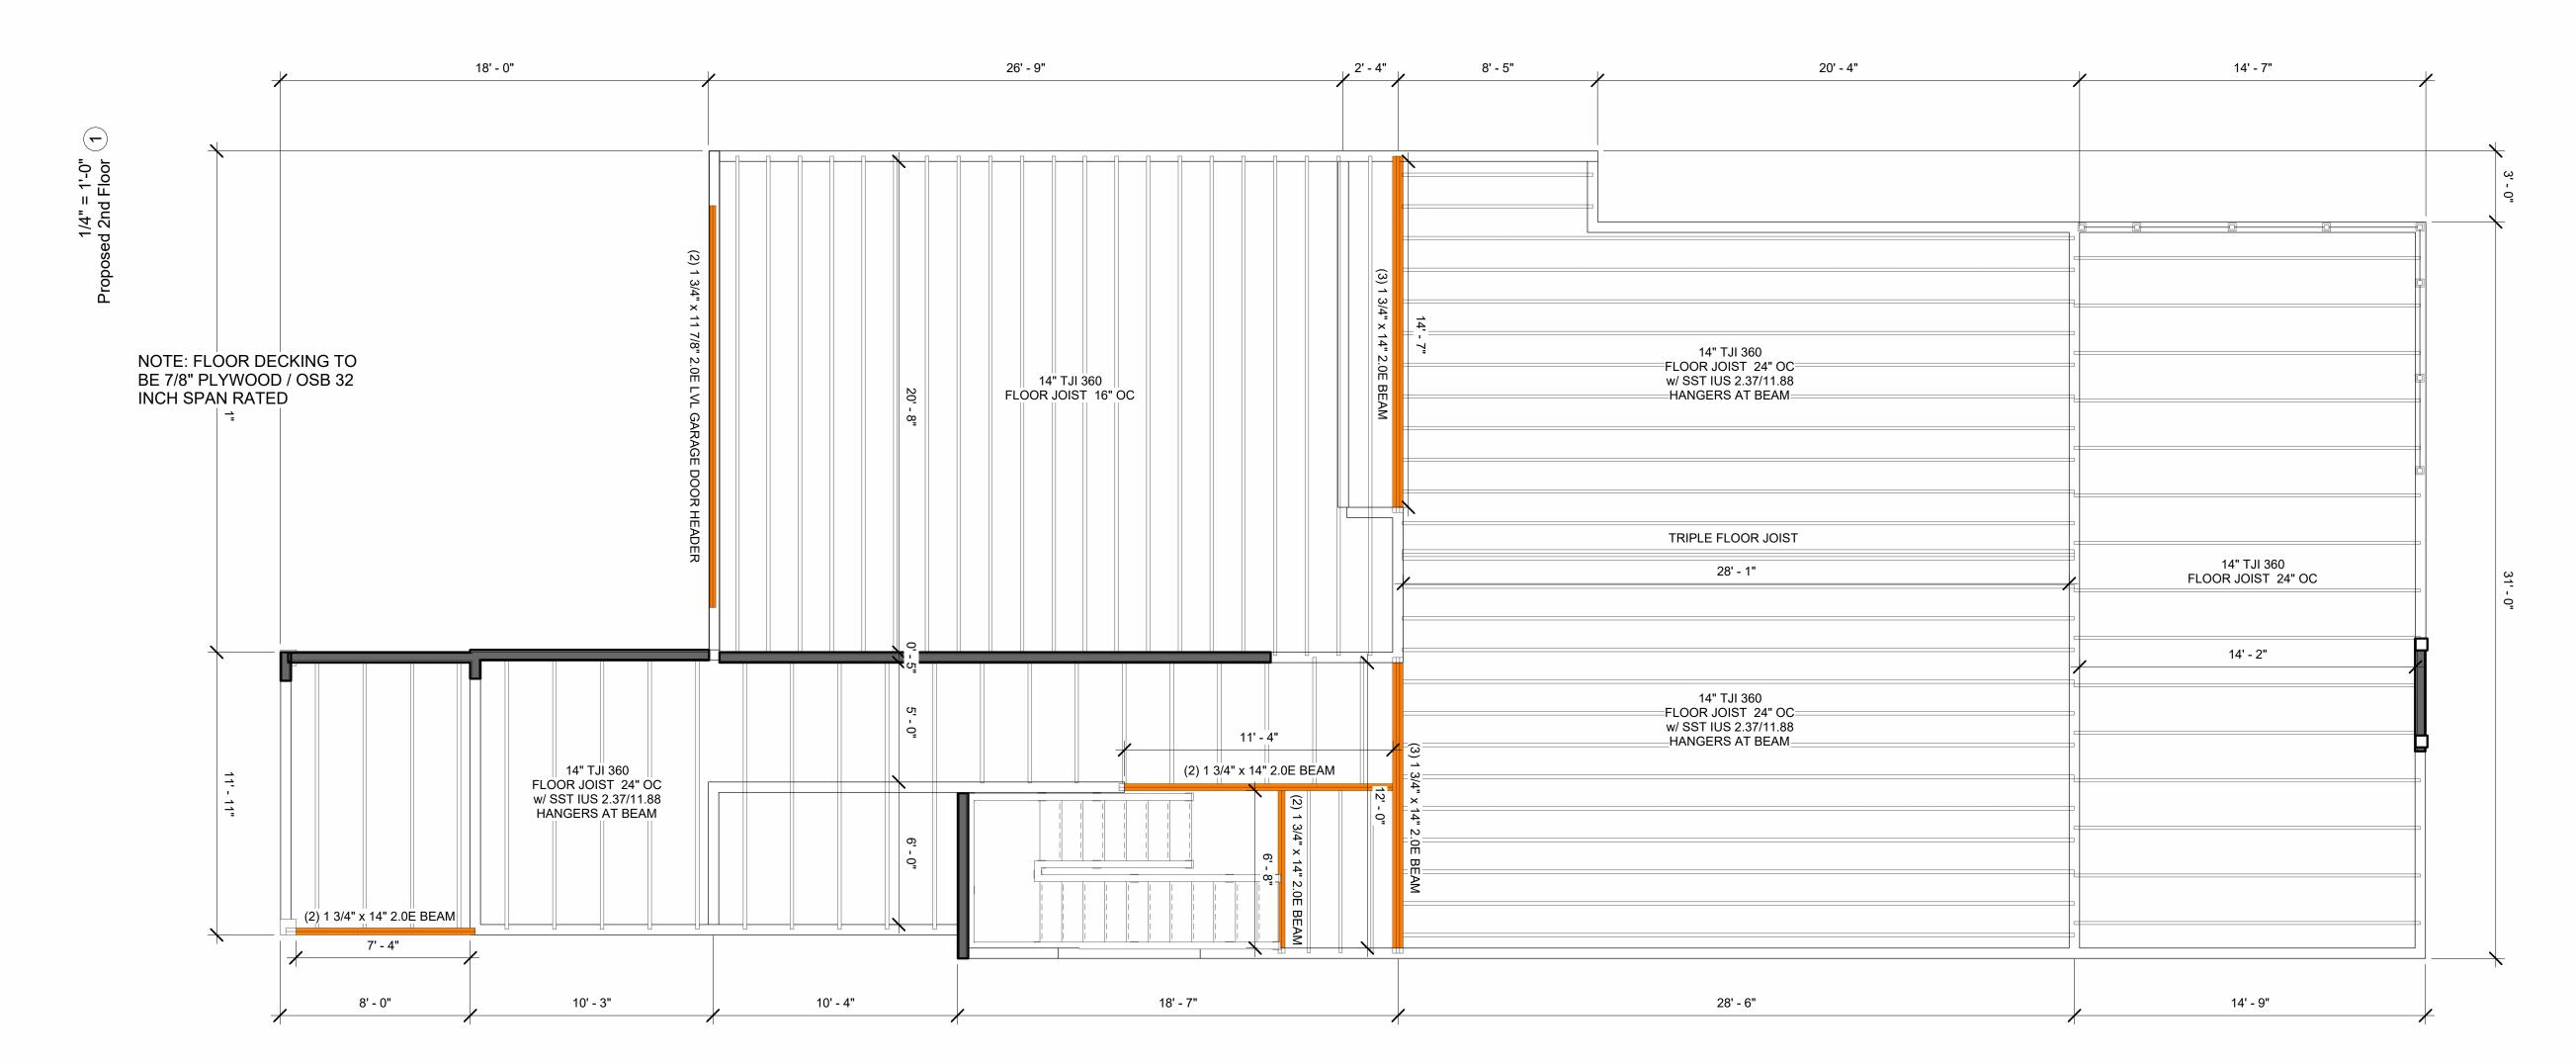Name: Trent White
Company: Triton Holdings
Contact: twhite@triton.holdings



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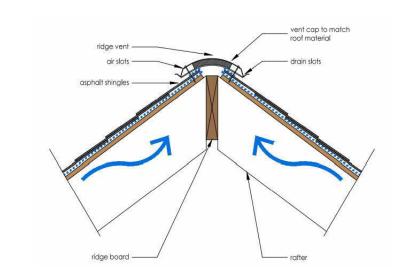
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2nd Flo	or Framing Plan


and Floor Framing Plan


\$102

Scale

As indicated



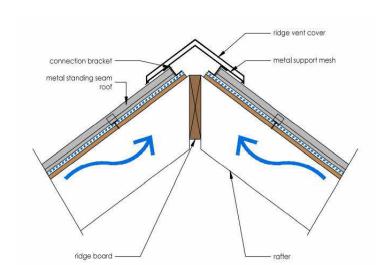

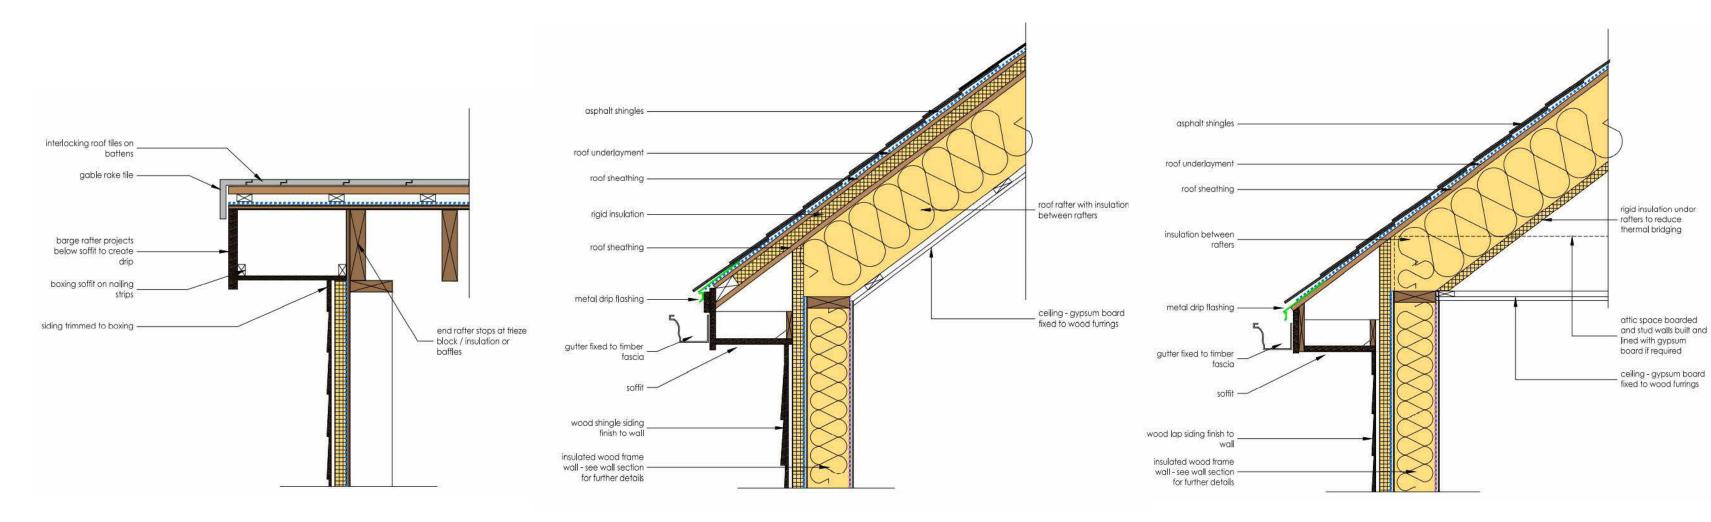

2 ROOF FRAMING DETAILS 1" = 1'-0"

ROOF & FRAMING NOTES:

- 1. FRAMING IS FOR ILLUSTRATION ONLY. ALL FRAMING SHALL BE INSTALLED & BRACED TO MANUFACTURER'S DRAWINGS & SPECIFICATIONS
- 2. ALL TRUSSES OR TJI'S SHALL CARRY MANUFACTURER'S STAMP
- 3. TRUSSES OR TJI'S SHALL NOT BE FIELD ALTERED WITHOUT PRIOR ENGINEERING APPROVAL
- 4. ALL TRUSSES OR TJI'S SHALL HAVE DESIGN DETAILS & DRAWINGS ON SITE FOR
- 5. ALL CONNECTIONS OF RAFTERS, JACK OR HIP TRUSSES TO MAIN GIRDER TO BE PROVIDED BY TRUSS MANUFACTURER
- 6. ROOF JOIST TO BE TJI 560 OR EQUIVALENT
- 7. ALL ROOF FRAMING 24" O.C.UNO
- 8. ALL ROOF OVERHANGS 16" UNO
- 9. INSTALL ICE SHIELD AS REQUIRED
- 10. INSTALL POLYISOCYANURATE FOAM TYPE INSULATION AT FLOOR AND PLATE LINES, OPENINGS IN PLATES, CORNER STUD CAVITIES AND AROUND DOOR AND WINDOW ROUGH OPENING CAVITIES.
- 11. MIN. SNOW LOAD SHALL BE 25 LBs PER SQUARE FOOT
- 12. ROOF SHEATHING 15/32" OSB OR 1/2" PLYWOOD 32/16 APA RATED W/ 8d @ 6" O/C ALL SUPPORTED PANEL EDGES, 12" O/C FIELD
- 13. ROOF TRUSS OR TJI'S MANUFACTURER:



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Name: Trent White Company: Triton Holdings Contact: twhite@triton.holdings



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6/6/2023 3:28:55 PM Drawn by Author Checked by Checker Sheet Title:

Roof Plan

S-103

Scale

As indicated

